

#### **ADDENDUM**

Public Building Commission of Chicago | Richard J. Daley Center | 50 West Washington Street, Room 200 | Chicago, Illinois 60602 | (312) 744-3090 | pbcchicago.com

ADDENDUM NO.: 04

PROJECT NAME: Salt Dome Replacement Facility (Grand Avenue)

PROJECT NO.: 04021

CONTRACT NO.: C1598

DATE OF ISSUE: January 27, 2021

# NOTICE OF CHANGES, MODIFICATIONS, OR CLARIFICATIONS TO CONTRACT DOCUMENTS

The following changes, modifications, or clarifications are hereby incorporated and made an integral part of the Contract Documents. Unless clearly expressed otherwise by this Addendum, all terms and conditions defined in the original Contract Documents shall continue in full force and effect and shall have the same meaning in this Addendum. Issued Addenda represent responses/clarifications to various inquiries. Contractors shall be responsible for including all associated labor/material costs in its bid. Drawings/specifications corresponding to inquiry responses will be issued with the Issue for Construction Documents, upon issuance of building permit.

ITEM NO. 1: CHANGE TO KEY DATES

None.

ITEM NO. 2: REVISIONS TO BOOK 1 – PBC INSTRUCTIONS TO BIDDERS

Change 1 Page 6, Section II(E), REMOVE

#### E. Time of Completion

Substantial Completion must be achieved no later than September 30, 2021. Schedule Milestones must be completed as follows:

Milestone Descriptions	Milestone Dates
Substantial Completion	September 30, 2021
Milestone #1: De-Mobilization	September 30, 2021
Milestone #2: Re-Mobilization	April 1, 2022
Milestone #3: Site Improvements	June 30, 2022

#### And REPLACE WITH:

#### E. Time of Completion

Substantial Completion must be achieved no later than September 30, 2021. Schedule Milestones must be completed as follows:

Milestone Descriptions	Milestone Dates
Substantial Completion and De-Mobilization	September 30, 2021
Milestone #1: Re-Mobilization	April 1, 2022
Milestone #2: Site Improvements	June 30, 2022

Change 2 REMOVE Page 14 'B. Bid Form – C1598 Salt Dome Replacement Facility (Grand Avenue)' and REPLACE WITH 'B. Revised Bid Form – C1598 Salt Dome Replacement Facility (Grand Avenue)'. Alternate #1 language was updated. Note: Revised Bid Form includes Award Criteria Figure Formula

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Spreadsheet. Bidders may choose to populate spreadsheet or provide Pages 19 and 20 of 51 for each individual scenario.

Change 3 Page 17 Section IV(D) REMOVE '#1: Reduce Existing Landscape Wall Along Grand Avenue (add)' and REPLACE WITH '#1: Repair Existing Landscape Wall Along Grand Avenue (add)'

#### ITEM NO. 3: REVISIONS TO BOOK 2 – PBC STANDARD TERMS AND CONDITIONS

None.

#### ITEM NO. 4: REVISIONS TO BOOK 3 – TECHNICAL SPECIFICATIONS

None.

#### ITEM NO. 5: REVISIONS TO DRAWINGS

**Change 1 REVISED** Drawing No. AS1.1, Site Plan: Keynote N014 revised to clarify surface material. Surface material adjacent to dome revised to match civil drawings.

**Change 2 REVISED** Drawing No. C1.2, Overall Site Plan: Updated note 1 to clarify scope of work related to asphalt millings. Added note 6 and updated legend and callouts to clarify scope of proposed gravel surface.

**Change 3 REVISED** Drawing No. C1.2A, Overall Site Plan (Alternates): Updated note 1 to clarify scope of work related to asphalt millings. Updated note 3 to clarify alternate #1 scope of work. Added note 6 and updated legend and callouts to clarify scope of proposed gravel surface.

**Change 4 REVISED** Drawing No. E1.1, Site Lighting Plan: Lighting fixture schedule and notes 3 & 4 update for clarity. Sheet scale fixed.

**Change 5 REVISED** Drawing No. E1.2, Site Power Plan: Note 8 and relevant callouts revised for clarity. Sheet scale fixed.

**Change 6 REVISED** Drawing No. S1.1, Foundation Plan: Note B revised to update floor slab subbase design.

**Change 7 REVISED** Drawing No. S3.1, Details: Detail 105 revised to update floor slab subbase design. Details 101, 102, and 103 revised to properly identify anchor bolt details.

**Change 8 REVISED** Drawing No SM-1, Notes; Note 21 was added for the Contractor to assume a minimum quantity of stabilization reagent required.

**Change 9 REVISED** Drawing No. V0.1, Topographic and Utility Survey; revised to provide improved quality of topographic survey.

#### ITEM NO. 6: REQUESTS FOR INFORMATION

RFI-1.

Question: Please confirm we should schedule a site walk through you or if we can visit at any time as long

as we don't impact current operations.

Response: No site visit has been scheduled. Bidders may visit the site. Bidders are advised that the existing Salt

Dome is fully operational and may be executing a snow program, pending weather conditions. Bidders shall not impact facility operations. Proper PPE must be worn and proper COVID-19 protocols in accordance with CDC guidelines must be followed. Please refer to Book 1, Page 5,

(II)(A)(11) for further details.

RFI-2.

Question: Reference: Division 13 17 00 Inflated Form Thin Shell Concrete Dome

a. In the specification Ramco Construction, L.L.C is listed as a Dome Contractor. Will there be any

other contractors accepted? Please clarify.?

Response: Specification 13 17 00 Inflated Form Thin Shell Concrete Dome will be updated in subsequent Addendum.

RFI-3.

Question: Reference Book 1, Section II Project Information, Paragraph II.E Time of Completion and II.H

Liquidated Damages. Paragraph H indicates liquidated damages of \$1,500.00 per day for substantial completion and \$2,500.00 per day for each Milestone date that was not achieved. Since both the Milestone #1 De-Mobilization date and Substantial Completion date are both September 30, 2021, will both \$1,500.00 per day and \$2,500.00 per day, total of \$4,000.00 per day, be assessed

if the September 30, 2021 date is not achieved?

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Response: No, the sum total amount of \$4,000 will not be assessed for not achieving Substantial Completion ("SC")

and completing Milestone #1 in accordance with the Time of Completion requirements. However, \$2,500 will be assessed for not achieving SC in accordance with the Time of Completion requirements. The Time

of Completion requirements have been revised and are included in this Addendum.

RFI-4.

Question: Reference: Electrical (E1.1)

a. Per Drawing E1.1, Note # 4, does this new pole replacement refer to only ONE pole or, is this a "TYP" note for all the pole mounted fixtures? If it is typical, does it contradict Note # 3 on the

same page?

Response: Please refer to Drawing Sheet E1.1 Notes #2, #3, and #4, each only refer to the poles as identified on

the plan view callouts. Note #4 refers to only one (1) pole and is not a typical condition.

RFI-5.

Question: (Electrical E1.1) Also, per Notes # 3 & # 4, is the existing areas cable to be re-used to feed new

fixture & pole referenced on page, and above (herein)?

Response: Drawing Sheet E1.1 has been revised and included in this Addendum. Notes #3 and #4 on E1.1 shall

include the following change: "Extend existing electrical aerial cable" shall be revised to "extend existing

electrical aerial cable with new electrical aerial cable".

RFI-6.

Question: Per Note # 6, Drawing E1.1, will the light fixtures come with integral phot-cells or is the contractor

responsible for the supply & install of the noted photocells apart from the noted light fixtures?

**Response:** Drawing Sheet E1.1 has been revised and included in this addendum. Please refer to the revised lighting

fixture's schedule, the Contractor shall be responsible for procuring and installing the new photocells.

RFI-7.

Question: (Electrical E1.2) Per the note regarding the "Yellow Boxes", page E1.2, is electrical to simply

"rotate the boxes to face WEST, or is there more to this relocation effort? Where are the existing boxes currently? The note is slightly ominous in its projection of the work effort, please advise.

Response: Drawing sheet E1.2 has been revised and included in this Addendum. Per Note #8, "Contractor to replace

Hubbell Power Boxes, Detail "C" and "D" with Appleton Unilet Single Cover For GFCI FSCD Box".

RFI-8.

Question: (Electrical E1.2) Is Note # 8, Drawing E1.2 referring to the "Yellow Boxes"? See below.

8. CONTRACTOR TO REPLACE HUBBELL POWER BOXES, DETAIL "C" AND "D" WITH APPLETON UNILET SINGLE COVER FOR GFCI FSCD BOX. PROVIDE COMPLETE ASSEMBLY 240V, 20AMP DISCONNECT SWITCH, NEMA 6-20R CONFIGURATION RECEPTACLE AND PLUG AND CABLE ASSEMBLY WITH FEMALE PLUG, FOR EACH HUBBELL POWER BOX, CONTRACTOR TO INSTALL TWO APPLETON UNILET FSCD BOXES, SEE DETAILS "E" AND "F"

ON SHEET E1.3.

Response: Drawing sheet E1.2 has been revised and included in this addendum. Note #8 refers to the yellow boxes

as shown in Details "C" and "D".

RFI-9.

Question: Drawing S0.1 – This drawing specifies grade 60 rebar. Is there an opportunity for the bidder to

value engineer the structure to use 75 ksi bar which may reduce steel tonnage and potentially

decrease the thickness of the shotcrete?

**Response:** Contractor is to construct as detailed on Sheet S0.1.

RFI-10.

Question: Specifications Book 3; Volume 13 17 00 (Part 2 - PRODUCTS), Section 2.2-C (Page 60 of 232) -

This specification states: "Basis of Design: Seaman corporation, Shelter-Rite high performance 8028 FRLTC Architectural Fabric." Will an alternate fabric of equal or improved quality be

accepted?

**Response:** An alternate fabric may be accepted if it meets all specified requirements and is approved by the engineer.

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RFI-11.

Question: **Regarding Print E1.1 Site Lighting Plan** 

- Note 4 states to locate the new pole 150' from the last pole however, it measures only 65' away according to the print scale (1" = 30"). Please clarify the correct distance.
- Are the light poles, P1-P9 at the correct scaled distance on the print?

Response: Drawing sheets E1.1 and E1.2 have been revised and included in this addendum. Note #4 on sheet E1.1 to state "CONTRACTOR SHALL INSTALL NEW 45 FT WOOD POLE WITH NEW LED FIXTURE. EXTEND EXISTING ELECTRICAL AERIAL CABLE AND TERMINATE AT FIXTURE. LOCATE NEW POLE APPROXIMATELY 70 FT AWAY FORM THE LAST POLE TO SUIT FIELD CONDITIONS."

RFI-12.

Question: Regarding Print E1.2 Site Power Plan

- There are discrepancies with the notes on E1.2. Please confirm the scope of work with all Hubbell boxes on the east side of the salt dome.
- Please clarify the correct spaces in the 100A panels to be replaced. (30? 42?)
- Please clarify if the 30A breakers requested on the print are single pole or 2 pole.

Response: Drawing E1.2 has been revised and included in this addendum -A total of 13 Hubbell boxes are being replaced on the WEST side of the dome as shown on Sheet E1.2. None are being replaced on the east side of the dome.

- -Spacing will be 4-30A, 2 pole breakers.
- -Revision identifies the 30A breakers as 2 pole.

RFI-13.

Question:

Specification 32 13 13, Part 3.8B mentions LM Schofield Company color lithochrome wax as a curing compound to match the colored concrete. However, the drawings do not indicate any colored concrete. Please confirm if colored concrete is required. If so, please define the limits of the colored concrete.

There will be no colored concrete required for this project. Response:

RFI-14.

Question:

Reference: Electrical - Please clarify the 1" PVC conduit shown on E1.2. Is it to be installed inside the concrete wall, or surface mounted on the inside face of the wall? Is it PVC or PVC coated rigid conduit? Is it empty or is it to be used to feed the lighting on the south side of the dome?

Response:

Per sheet E1.2: 1" PVC SCH-40 CONDUIT RUN WITHIN THE DOME WALL, in accordance with the contract documents. Conduit shall be used to feed the lighting on the south side of the dome.

RFI-15.

Question:

Reference: Electrical - There is a note on the lower left corner of E1.2 that says we are to replace 13 Hubbell 240V Power Boxes with 2 pole breakers. It looks like Note 7 and 8 apply to this replacement. Note 8 refers to E1.3 Detail E, which shows a 120V device. Is the intent to replace the 240V Hubbell boxes and have them feed 2 Nema 6-20R receptacles mounted similar to E1.3 detail E? Are GFI breakers required in the Hubbell boxes?

Response:

Drawing Sheet E1.2 note #8 has been revised and included in this addendum to clarify the design intent. Hubbell boxes should be replaced with Appleton unilet cover FSCD box, completely assembled (2) 240V 30amp breakers or disconnect switch and NEMA 6-30R configuration, 30A GFI receptacle plug and cable assembly. Note 7 and 8 have been revised and apply to this replacement. Detail E on sheet 1.3 is shown for reference only.

RFI-16.

Question:

Reference: Electrical - E1.2 note 10 refers to reconnecting power to trailers. Please clarify the scope of work required for this note.

**Response:** Contractor will be responsible for restoring the ComEd electrical service to the existing site trailers upon completion of the work.

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Question: Reference Excavation - Drawing SM-1 – Please confirm that all hatched areas go to Subtitle-D.

**Response:** Confirmed. Excavated material within the hatched areas on SM-1 should be disposed of at a Subtitle-D facility. The only exception is clean pavement materials or asphalt millings, which may be taken to

appropriate recycling facilities as per the Specifications and Drawing notes.

RFI-18.

Question: Reference Excavation - Keynote 20 calls for Removal of 356 cy of soil with Hazardous Lead. Please

confirm this is only in the area shown as solid grey.

Response: Confirmed. The area shown in solid gray on SM-1 is the only known area with hazardous lead in soil,

based on the environmental sampling and analysis performed to date.

RFI-19.

Question: Drawings SM-2 outlines a "Engineered Barrier Area" which requires 3' or 18" clean fill barrier.

a. Please confirm whether concrete pavement, asphalt and salt dome SOG meet the requirement of the engineered barrier.

b. Please confirm whether the asphalt milling/CA-6 6" depth is included in the 18" or 3" clean fill barrier depth outside of the paved areas?

**Response:** a. Confirmed. Concrete pavement, asphalt, and concrete floor slab meet the requirements of the engineered barrier.

b. The proposed 6" CA-6 surface shall apply to the engineered barrier, so long as it meets all the additional engineered barrier requirements. The existing asphalt grindings should not be used as engineered barrier, unless they meet the requirements of note #2: "ASPHALT GRINDINGS THAT ARE ALREADY PRESENT AT THE SURFACE AND UNDISTURBED CAN BE USED AS THE ENGINEERED BARRIER".

RFI-20.

Question: Please confirm whether any excavation from with the Engineered Barrier Area can be reused

onsite as fill.

**Response:** Excavated material in the engineered barrier may not be re-used for on-site fill.

RFI-21.

Question: C1.2 and C1.2A notes one states that "The existing asphalt millings shall be taken hauled offside

due to environmental concerns." Please confirm the depth of removal required.

Response: Please refer to Contract Documents regarding on site material. Existing asphalt millings may be left in

place if undisturbed. Any asphalt millings that are disturbed must be properly handled and disposed of,

in accordance with the Contract Documents.

RFI-22.

Question: The Architectural site plans indicate that the surface outside of paved areas is to be covered in

asphalt millings. C1.2 indicates that the surface outside of pavement is to be 6" of CA-6. Which is

correct?

**Response:** Revised Drawing sheet C1.2, C1.2A and AS1.1, have been revised and included in this Addendum. The

Contractor should assume that the typical surface outside of paved areas is a minimum of 6" of CA-6.

Where existing asphalt milling surface exceeds 3" and is undisturbed it may be left in place.

RFI-23.

Question: Page 7/8 of the AECOM geotechnical report recommends that the upper two feet of material

beneath the dome SOG consist of compacted CA-6. The drawings indicate 8" of subbase stone

under the SOG. Are we to follow the geotechnical recommendations?

Response: Drawing sheet S3.1 and S1.1 has been revised and included in this Addendum to show 24" of subbase

stone underneath the proposed slab.

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RFI-24.

Question: Bid form lists alternate #1 as reduce existing landscape wall along grand avenue (add). Alternate

note #3 on C1.2A indicates for it to be repaired and replaced as needed. Please confirm alternate

intent and what scope that should be included in base bid.

Response: Contractors base bid shall not include any work related to the landscape wall. Refer to the revised

Drawing sheet C1.2A note #3 for Alternate #1 scope details and included in this Addendum.

RFI-25.

Question: Page C1.2 calls out 6" of CA-6 aggregate within the fenced in area. Page C1.2A calls out this same

area as existing asphalt milling to be removed per note 1, but does not reference an alternate.

Please define the asphalt milling alternate scope.

Response: Refer to RFI #35 response regarding the CA-6 requirements. Drawing sheet C1.2A has been revised and

included in this Addendum to match the base scope of work for the proposed gravel surface.

RFI-26.

Question: Is aluminum triplex cable acceptable as aerial cable for the Pole lights?

Response: No, aluminum triplex cable is not acceptable as aerial cable for the pole lights.

RFI-27.

Question: Will the Underground electric excavation and backfill be performed utilizing the Site work

allowances?

Response: No, the Contractor shall not assume that the excavation and backfill work required for the underground

electric or any other utility work will be paid from the Site Work Allowance Schedule. The Contractor shall assume in its base bid all cost associated with excavation and back-fill for utilities, in accordance with the

Contract Documents.

RFI-28.

Question: Will the construction trailers be sitting vacant from September 30, 2021 to April 1, 2022? Will

trailers be required for Phase 2 site improvements?

**Response:** As noted on Drawing Sheet A0.1 note #5 of the Contract Documents, Contractor is not required to provide

construction trailer during construction. Construction field offices are available for the Contractors use for

the duration of the project (located at adjacent property, 2505 W Grand Ave).

RFI-29.

Question: PDF plans for the salt dome project are raster files, we have already checked with Cross Rhodes.

We need vector files to be able to manipulate and read the blurry plans, specially sheet V0.1. The

engineer/designer should have vector PDF's.

**Response:** Drawing Sheet V0.1 has been revised and included in this Addendum.

RFI-30.

Question: Please provide plans with elevation labels on existing contour lines, the current plans do not

show label on existing contour lines.

**Response:** Drawing Sheet V0.1 has been revised and included in this Addendum.

RFI-31.

Question: Please specify who is responsible for moving the tire piles?

**Response:** The Contractor is not responsible for moving the tire piles. The tire piles will be removed by others prior

to April 1, 2021.

RFI-32.

Question: Will the owner provide staging area for the concrete blocks to be temporarily removed?

Response: Contractor shall be responsible for relocating concrete blocks as necessary to facilitate its work in

accordance with the Contract Documents. Refer to C1.2, Note #2.

RFI-33.

Question: Sheet C1.2Al appears as if the PCC alternate reduction is part of alternate #2. Please clarify.

Response: Drawing Sheet C1.2A has been revised and included in this Addendum. There is no PCC reduction as

part of alternate #2. The noted PCC reduction of 1,771 SY should be included as part of alternate #3.

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RFI-34.

Question: Confirm that in the base bid the PCC pavement around the salt dome does not require barrier

curb, nor curb and gutter.

Response: Confirmed. The base bid does not include curb and gutter around the salt dome, please refer to C1.2A.

RFI-35.

Question: Please advise if the contractor can we reuse excavation spoils for fill.

**Response:** The Contractor shall not reuse excavation spoils for fill. All spoils should be hauled to a subtitle D facility.

RFI-36.

Question: Reference sheet C1.2 note 1 "The existing asphalt millings shall be taken hauled offside due to

environmental concerns". Borings SB-2, SB-3, SB-4 show asphalt as a the top layer, however the plans does not show enough information to determine an square footage where asphalt is

present. Please provide a more accurate plan with sections/areas for existing conditions.

Response: Please refer to Drawing Sheet C1.1. It identifies the extents of pavement removal that shall be

anticipated. The remaining surface materials shall be assumed to be asphalt millings ranging from 6" to

18" in thickness per the reports available in Book 2 Appendix of the Contract Documents.

RFI-37.

Question: Reference specification 312000/1.3/d/F/3 "Unauthorized excavation: excavation below subgrade

elevations..." All earthwork cuts required for grading and foundations are below existing

subgrade elevation. Please clarify what exactly is "unauthorized excavation".

**Response:** Please refer to Specification Section 31 20 00 Section 1.3 L, Subgrade is as "Uppermost surface of an

excavation or the top surface of a fill or backfill immediately below subbase, drainage fill, drainage course,

or topsoil materials." Unauthorized excavation shall be as defined.

RFI-38.

Question: Please confirm that all subgrade below proposed building footings, slabs, asphalt, PCC

pavement, shall be proof-roll per specifications 312000/3.9/D.

**Response:** Exposed subgrade areas shall be proof-rolled per specification.

RFI-39.

Question: Please confirm that all subgrade below CA-6 aggregate around dome will not require proof-roll.

**Response:** Subgrades in areas of proposed aggregate surface do not require proof rolling.

RFI-40.

Question: Reference detail 105 on sheet S3.1. Please confirm that 8" of compacted sub-base material under

dome floor will suffice as engineered barrier.

**Response:** Pavement material shall act as an environmental engineer barrier at this location. The proposed concrete

slab will act as the engineered barrier.

RFI-41.

Question: Reference sheet C-1.6. Please confirm that the fill elevations shown are to final elevation.

**Response:** Sheet C1.6 details the cut/fill to the final proposed grade.

RFI-42.

Question: Reference sheet C-1.6. Please confirm that the fill volume of 8,544 CY includes proposed concrete,

asphalt and PCC volumes.

Response: Please reference Drawing Sheet C1.6. The fill volume is shown as 12,030 CY. Excavated soil material

from cut areas cannot be reused as fill. Sheet C1.6 does not make any adjustments for material volumes. The cut/fill volumes are calculated based upon the difference between the existing and final grades.

RFI-43.

Question: Will the contractor be required to furnish the new concrete barricades around the proposed

parking lot shown on sheet C1.2?

**Response:** Please refer to C1.2 note #3, the Contractor shall stockpile existing barricades on-site and place them as

shown on Drawing Sheet C1.2 upon completion of work. Surplus barricades to be distributed along

perimeter fence.

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RFI-44.

Question: Per sheet SM-2, the area south if the dome will require an engineered fill, however this area is a

cut. Does the elevations shown on C-1.6 include the engineered barrier or the contractor will need

to undercut the cut areas even more to provide the engineered fill.

**Response:** The contractor shall excavate below the proposed final grade referenced on Drawing Sheet C1.6 in order

to provide the engineered barrier.

RFI-45.

Question: Please clarify if the cut areas that are not concrete or asphalt will required an engineered fill.

**Response:** The engineered barrier will be required as shown on sheet SM-2, regardless of cut/fill.

RFI-46.

Question: Drawing sheet A0.1, phase 2 layout indicates "Provide protection 20' from dome perimeter".

Please clarify what type of protection is required at this location.

**Response:** Please provide a Construction fence 20' from the dome perimeter.

RFI-47.

Question: Drawing sheet AS1.1, keynote N009 indicates "10' Jersey Barricades". Sheet C1.2, note 3

indicates concrete barricades to be stockpiled on site and placed as shown upon completion of work. Surplus barricades to be distributed along perimeter fence. Are the concrete barricades noted on sheet C1.2 the same as the 10' Jersey Barricades noted on sheet AS1.1? If not, please clarify what concrete barricades are being referred to on sheet C1.2. Also, if the 10' Jersey Barricades are new, there is no specification provided for the Barricades. Please provide

specification.

Response: Confirmed. The jersey barricades identified on Drawing Sheet AS1.1 are the same as indicated on

Drawing Sheet C1.2.

RFI-48.

Question: Drawing sheet C1.2, shows a ring of 6" CA-6 aggregate between the dome and the concrete

pavement. Sheet C1.2A shows this same ring as reclaimed asphalt millings. Sheet A1.1 shows this same ring as replaced gravel millings. Sheet AS1.1 shows this same ring to be top soil and seeding. Please clarify what is to be placed between the dome and the concrete pavement around

the dome.

Response: Drawing Sheet C1.2, C1.2A, and AS1.1 have been revised to show the scope of Work. The proposed

surface between the dome and the ring road shall be a 6" minimum thickness layer of CA-6.

RFI-49.

Question: Drawing sheet C1.2, note #1 indicates "The existing asphalt millings shall be taken hauled offsite

due to environmental concerns". Sheet SM-1, note 10 indicates "Existing asphalt grindings are allowed to remain in place on the surface of the site if they are undisturbed". Please clarify if all asphalt grindings within the work area are to be taken off site or only asphalt gradings disturbed.

Response: Drawing Sheet C1.2 has been revised and included in this Addendum to be consistent with SM-1. All

excavated or disturbed asphalt grindings are to be properly disposed to a Subtitle D facility. The

Contractor should not reuse excavation spoils for fill.

RFI-50.

Question: Foundation details 101, 102 & 103 on sheet S3.1 show an anchor bolt located on the exterior side

of the foundation. Please provide information on type, size and spacing of the anchor bolt shown...

**Response:** Drawing Sheet S3.1 has been revised and included in this Addendum to identify the anchor bolt type,

size, and spacing are shown in detail 104.

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This Addendum includes the following attached Specifications and/or Documents:

- 1. B. Revised Bid Form C1598 Salt Dome Replacement Facility (Grand Avenue) in PDF
  - a. Please note the Bid Form has been provided in PDF format in the event firm will not be completing or submitting in electronic format.
- 2. B. Revised Bid Form C1598 Salt Dome Replacement Facility (Grand Avenue) in EXCEL
  - a. Please note the Award Criteria Figure Formula Spreadsheet is included. There are two sheets in the Excel document.


This Addendum includes the following attached Drawings:

- 1. AS1.1 SITE PLAN, DATED 1/27/21
- 2. C1.2 OVERALL SITE PLAN, 1/27/21
- 3. C1.2A OVERALL SITE PLAN (ALTERNATES), 1/27/21
- 4. E1.1 SITE LIGHTING PLAN, DATED 1/27/21
- 5. E1.2 SITE POWER PLAN, DATED 1/27/21
- 6. S1.1 FOUNDATION PLAN, DATED 1/27/21
- 7. S3.1 DETAILS, DATED 1/27/21
- 8. SM-1 SOIL MANAGEMENT PLAN, DATED 1/27/21
- 9. V0.1 TOPOGRAPHIC AND UTILITY PLAN, DATED 1/27/21

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#### B. REVISED BID FORM - C1598 SALT DOME REPLACEMENT FACILITY (GRAND AVENUE)



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PROJECT NAME:	Salt Dome Replace	ment Facility (Grar	nd Avenue)									
CONTRACT NO:	C1598											
PROJECT NO:	04021											
				A	AWARD CRITE (For Hardcopy							
	Α	В	C	D	E	F	G	H		J	K	L
FORMULA	TOTAL BASE WORK ONLY	TOTAL BASE + ALT 1	TOTAL BASE - ALT 2	TOTAL BASE - ALT 3	TOTAL BASE - ALT 4	TOTAL BASE + ALT 1 - ALT 2	TOTAL BASE + ALT 1 - ALT 3	TOTAL BASE + ALT 1 - ALT 4	TOTAL BASE - ALT 2 - ALT 3	TOTAL BASE - ALT 2 - ALT 4	TOTAL BASE - ALT 3 - ALT 4	TOTAL BASE + AI 1 - ALT 2 - ALT 3 ALT 4
Line 1. (Based on Total Base Bid)												
Line 2. Minority Journeyman (Maximum figure 0.70)												
Line 3. Multiply Line 2 by Line 1 by 0.04												
Line 4. Minority Apprentice (Maximum figure 0.70) Line 5. Multiply Line 4 by Line 1 by 0.03												
Line 3. Multiply Line 4 by Line 1 by 0.03												
Line 6. Minority Laborer (Maximum figure 0.70) Line 7. Multiply Line 6 by Line 1 by 0.01												
Line 8. Female Journeyman (Maximum figure 0.15) Line 9. Multiply Line 8 by Line 1 by 0.04												
Line 10. Female Apprentice (Maximum figure 0.15) Line 11. Multiply Line 10 by Line 1 by 0.03												
Line 12. Female Laborer (Maximum figure 0.15) Line 13. Multiply Line 12 by Line 1 by 0.01												
line 44. Table filine 2.5.7.0.44 and 40.												
Line 14. Total of Lines 3, 5, 7, 9, 11, and 13 Line 15. Total Award Criteria												
TOTAL AWARD CRITERIA (Line 15)	\$	\$	\$	\$	\$	\$	\$	\$	\$	\$	\$	\$
Accepted by the Commission NOTES/INSTRUCTIONS						BIDDER'S IN	FORMATION					
1. Line 1. is based on Line 8 of Bid Form (Total Base B	3id)				Firm Name:	DIDDER O III						
2. Bidder is to populate Lines 2, 4, 6, 8, 10, and 12 (fie 3. Lines 2, 4, 6, 8, 10, and 12 are to be entered in deci 4. TOTAL AWARD CRITERIA - Re-enter Line 15	lds shaded Light Green).	= 0.05, 15% participation	= 0.15, 50% participation =	.50)	Submitted on:							
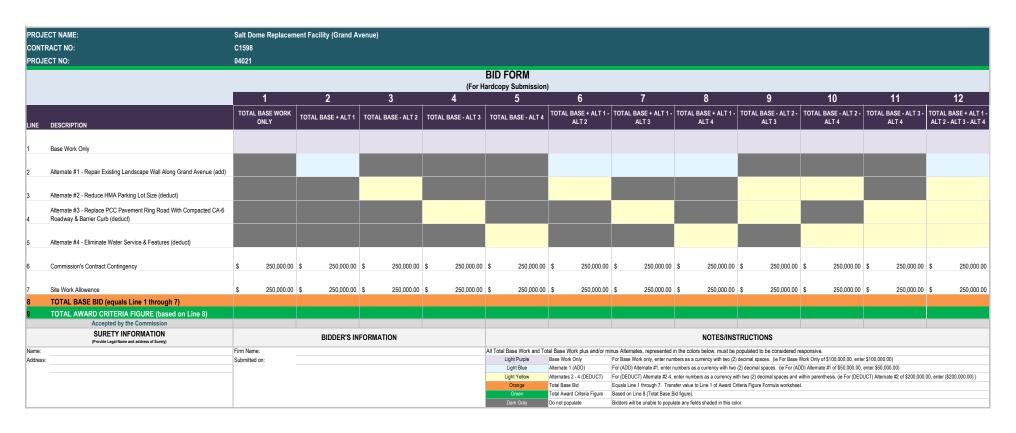
### B. REVISED BID FORM - C1598\_SALT DOME REPLACEMENT FACILITY (GRAND AVENUE)


PROJECT NAME:	Salt Dome Replacen	ment Facility (Grand A	venue)									
CONTRACT NO:	C1598											
PROJECT NO:	04021											
					BID FORM							
					tronic Submission Co	ору)						
	1	2	3	4	5	6	7	8	9	10	11	12
LINE DESCRIPTION	TOTAL BASE WORK ONLY	TOTAL BASE + ALT 1	TOTAL BASE - ALT 2	TOTAL BASE - ALT 3	TOTAL BASE - ALT 4	TOTAL BASE + ALT 1 - ALT 2	TOTAL BASE + ALT 1 - ALT 3	TOTAL BASE + ALT 1 - ALT 4	TOTAL BASE - ALT 2 - ALT 3	TOTAL BASE - ALT 2 - ALT 4	TOTAL BASE - ALT 3 - ALT 4	TOTAL BASE + ALT 1 - ALT 2 - ALT 3 - ALT 4
1 Base Work Only	\$ -	\$ -	s -	s -	\$ -	\$ -	\$ -	s -	\$ -	\$ -	s -	\$ -
2 Alternate #1 - Repair Existing Landscape Wall Along Grand Avenue (add)		\$ -				\$ -	\$ -	\$ -				\$ -
3 Alternate #2 - Reduce HMA Parking Lot Size (deduct)			\$0.00			\$0.00	0		\$0.00	\$0.00		\$0.00
Alternate #3 - Replace PCC Pavement Ring Road With Compacted CA-6 Roadway & Barrier Curb (deduct)				\$0.00			\$0.00		\$0.00		\$0.00	\$0.00
5 Alternate #4 - Eliminate Water Service & Features (deduct)					\$0.00			\$0.00		\$0.00	\$0.00	\$0.00
6 Commission's Contract Contingency	\$ 250,000.00	\$ 250,000.00	\$ 250,000.00	\$ 250,000.00	\$ 250,000.00	\$ 250,000.00	\$ 250,000.00	\$ 250,000.00	\$ 250,000.00	\$ 250,000.00	\$ 250,000.00	\$ 250,000.00
7 Site Work Allowance	\$ 250,000.00	\$ 250,000.00	\$ 250,000.00	\$ 250,000.00	\$ 250,000.00	\$ 250,000.00	\$ 250,000.00	\$ 250,000.00	\$ 250,000.00	\$ 250,000.00	\$ 250,000.00	\$ 250,000.00
8 TOTAL BASE BID (equals Line 1 through 7)	\$ 500,000.00	\$ 500,000.00	\$ 500,000.00	\$ 500,000.00	\$ 500,000.00	\$ 500,000.00	\$ 500,000.00	\$ 500,000.00	\$ 500,000.00	\$ 500,000.00	\$ 500,000.00	\$ 500,000.00
9 TOTAL AWARD CRITERIA FIGURE (based on Line 8)	\$ 500,000.00	\$ 500,000.00	\$ 500,000.00	\$ 500,000.00	\$ 500,000.00	\$ 500,000.00	\$ 500,000.00	\$ 500,000.00	\$ 500,000.00	\$ 500,000.00	\$ 500,000.00	\$ 500,000.00
Accepted by the Commission  SURETY INFORMATION (Provide Legal Name and address of Surety)		BIDDER'S IN	IFORMATION		NOTES/INSTRUCTIONS							
Name:	Firm Name:				All Total Base Work and Total Base Work plus and/or minus Alternates, represented in the colors below, must be populated to be considered responsive.							
Address:	Submitted on:				Light Purple Light Blue	Base Work Only Alternate 1 (ADD)	For Base Work only, enter nur For (ADD) Alternate #1, enter					
	1				Light Yellow	Alternates 2 - 4 (DEDUCT)	For (DEDUCT) Alternate #2-4,	first enter a minus symbol ('-'),	then enter numbers without deci		ICT) Alternate #2 of \$200,000.0	0, enter -200000)
					Orange	Total Base Bid	Equals Line 1 through 7. Tota	,,,,				
					Green Dark Gray	Total Award Criteria Figure  Do not populate	Based on Line 8 (Totat Base E Bidders will be unable to popu	* '		from Award Criteria Figure Worl	sneet.	
					- July Oldy -	populito	to popu	, 1000 01000 11 010 00				


Date of Issue: January 27, 2021

PROJECT NAME: Salt Dome Replacement Facility (Grand Avenue) CONTRACT NO: C1598 PROJECT NO: 04021 AWARD CRITERA FIGURE FORMULA (For Electronic Submission Copy) В D G C TOTAL BASE - ALT 2 TOTAL BASE - ALT 3 TOTAL BASE - ALT 4 TOTAL BASE - ALT 5 TOTAL BASE - ALT 2 TOTAL BASE - ALT 2 TOTAL BASE - ALT 2 TOTAL BASE - ALT 3 TOTAL BASE + ALT TOTAL BASE WORK TOTAL BASE + ALT 1 - ALT 2 - ALT 3 -**FORMULA** ONLY 1 - ALT 2 1 - ALT 3 1 - ALT 4 - ALT 3 - ALT 4 - ALT 4 ALT 4 Line 1. (Based on Total Base Bid) \$500,000.00 \$500,000.00 \$500,000.00 \$500,000.00 \$500,000.00 \$500,000.00 \$500,000.00 \$500,000.00 \$500,000.00 \$500,000.00 \$500,000.00 \$500,000.00 Line 2. Minority Journeyman (Maximum figure 0.70) \$0.00 \$0.00 \$0.00 \$0.00 \$0.00 \$0.00 \$0.00 \$0.00 \$0.00 \$0.00 \$0.00 \$0.00 Line 3. Multiply Line 2 by Line 1 by 0.04 \$500,000.00 \$500,000.00 \$500,000.00 \$500,000.00 \$500,000.00 \$500,000.00 \$500,000.00 \$500,000.00 \$500,000.00 \$500,000.00 \$500,000.00 \$500,000.00 Line 4. Minority Apprentice (Maximum figure 0.70) Line 5. Multiply Line 4 by Line 1 by 0.03 \$0.00 \$0.00 \$0.00 \$0.00 \$0.00 \$0.00 \$0.00 \$0.00 \$0.00 \$0.00 \$0.00 \$0.00 \$500,000.00 \$500,000.00 \$500,000.00 \$500,000.00 \$500,000.00 \$500,000.00 \$500,000.00 \$500,000.00 \$500,000.00 \$500,000.00 \$500,000.00 \$500,000.00 Line 6. Minority Laborer (Maximum figure 0.70) Line 7. Multiply Line 6 by Line 1 by 0.01 \$0.00 \$0.00 \$0.00 \$0.00 \$0.00 \$0.00 \$0.00 \$0.00 \$0.00 \$0.00 \$0.00 \$0.00 \$500,000.00 \$500,000.00 \$500,000.00 \$500,000.00 \$500,000.00 \$500,000.00 \$500,000.00 \$500,000.00 \$500,000.00 \$500,000.00 \$500,000.00 \$500,000.00 Line 8. Female Journeyman (Maximum figure 0.15) Line 9. Multiply Line 8 by Line 1 by 0.04 \$0.00 \$0.00 \$0.00 \$0.00 \$0.00 \$0.00 \$0.00 \$0.00 \$0.00 \$0.00 \$0.00 \$0.00 \$500,000.00 \$500,000.00 \$500,000.00 \$500,000.00 \$500,000.00 \$500,000.00 \$500,000.00 \$500,000.00 \$500,000.00 \$500,000.00 \$500,000.00 \$500,000.00 Line 10. Female Apprentice (Maximum figure 0.15) \$0.00 \$0.00 \$0.00 \$0.00 \$0.00 \$0.00 \$0.00 Line 11. Multiply Line 10 by Line 1 by 0.03 \$0.00 \$0.00 \$0.00 \$0.00 \$0.00 \$500,000.00 \$500,000.00 \$500,000.00 \$500,000.00 \$500,000.00 \$500,000.00 \$500,000.00 \$500,000.00 \$500,000.00 \$500,000.00 \$500,000.00 \$500,000.00 Line 12. Female Laborer (Maximum figure 0.15) Line 13. Multiply Line 12 by Line 1 by 0.01 \$0.00 \$0.00 \$0.00 \$0.00 \$0.00 \$0.00 \$0.00 \$0.00 \$0.00 \$0.00 \$0.00 \$0.00 \$500,000.00 \$500,000.00 \$500,000.00 \$500,000.00 \$500,000.00 \$500,000.00 \$500,000.00 \$500,000.00 \$500,000.00 \$500,000.00 \$500,000.00 \$500,000.00 Line 14. Total of Lines 3, 5, 7, 9, 11, and 13 \$0.00 \$0.00 \$0.00 \$0.00 \$0.00 \$0.00 \$0.00 \$0.00 \$0.00 \$0.00 \$0.00 \$0.00 Line 15. Total Award Criteria \$500,000.00 \$500,000.00 \$500,000.00 \$500,000.00 \$500,000.00 \$500,000.00 \$500,000.00 \$500,000.00 \$500,000.00 \$500,000.00 \$500,000.00 \$500,000.00 TOTAL AWARD CRITERIA (Line 15) \$500.000.00 \$500,000,00 \$500,000.00 \$500,000,00 \$500,000,00 \$500.000.00 \$500,000,00 \$500,000.00 \$500,000,00 \$500,000.00 \$500,000,00 \$500,000.00 Accepted by the Commission **BIDDER'S INFORMATION** NOTES/INSTRUCTIONS 1. Line 1. (Based on Total Base Bid) automatically populates from Bid Form. Firm Name: 2. Bidder is to populate Lines 2, 4, 6, 8, 10, and 12 (fields shaded Light Green). Submitted on: 3. Lines 2, 4, 6, 8, 10, and 12 are to be entered in decimals. (ie 5% participation = 0.05, 15% participation = 0.15, 50% participation = .50)

Date of Issue: January 27, 2021 Page 13 of 22

TOTAL AWARD CRITERIA automatically populates.

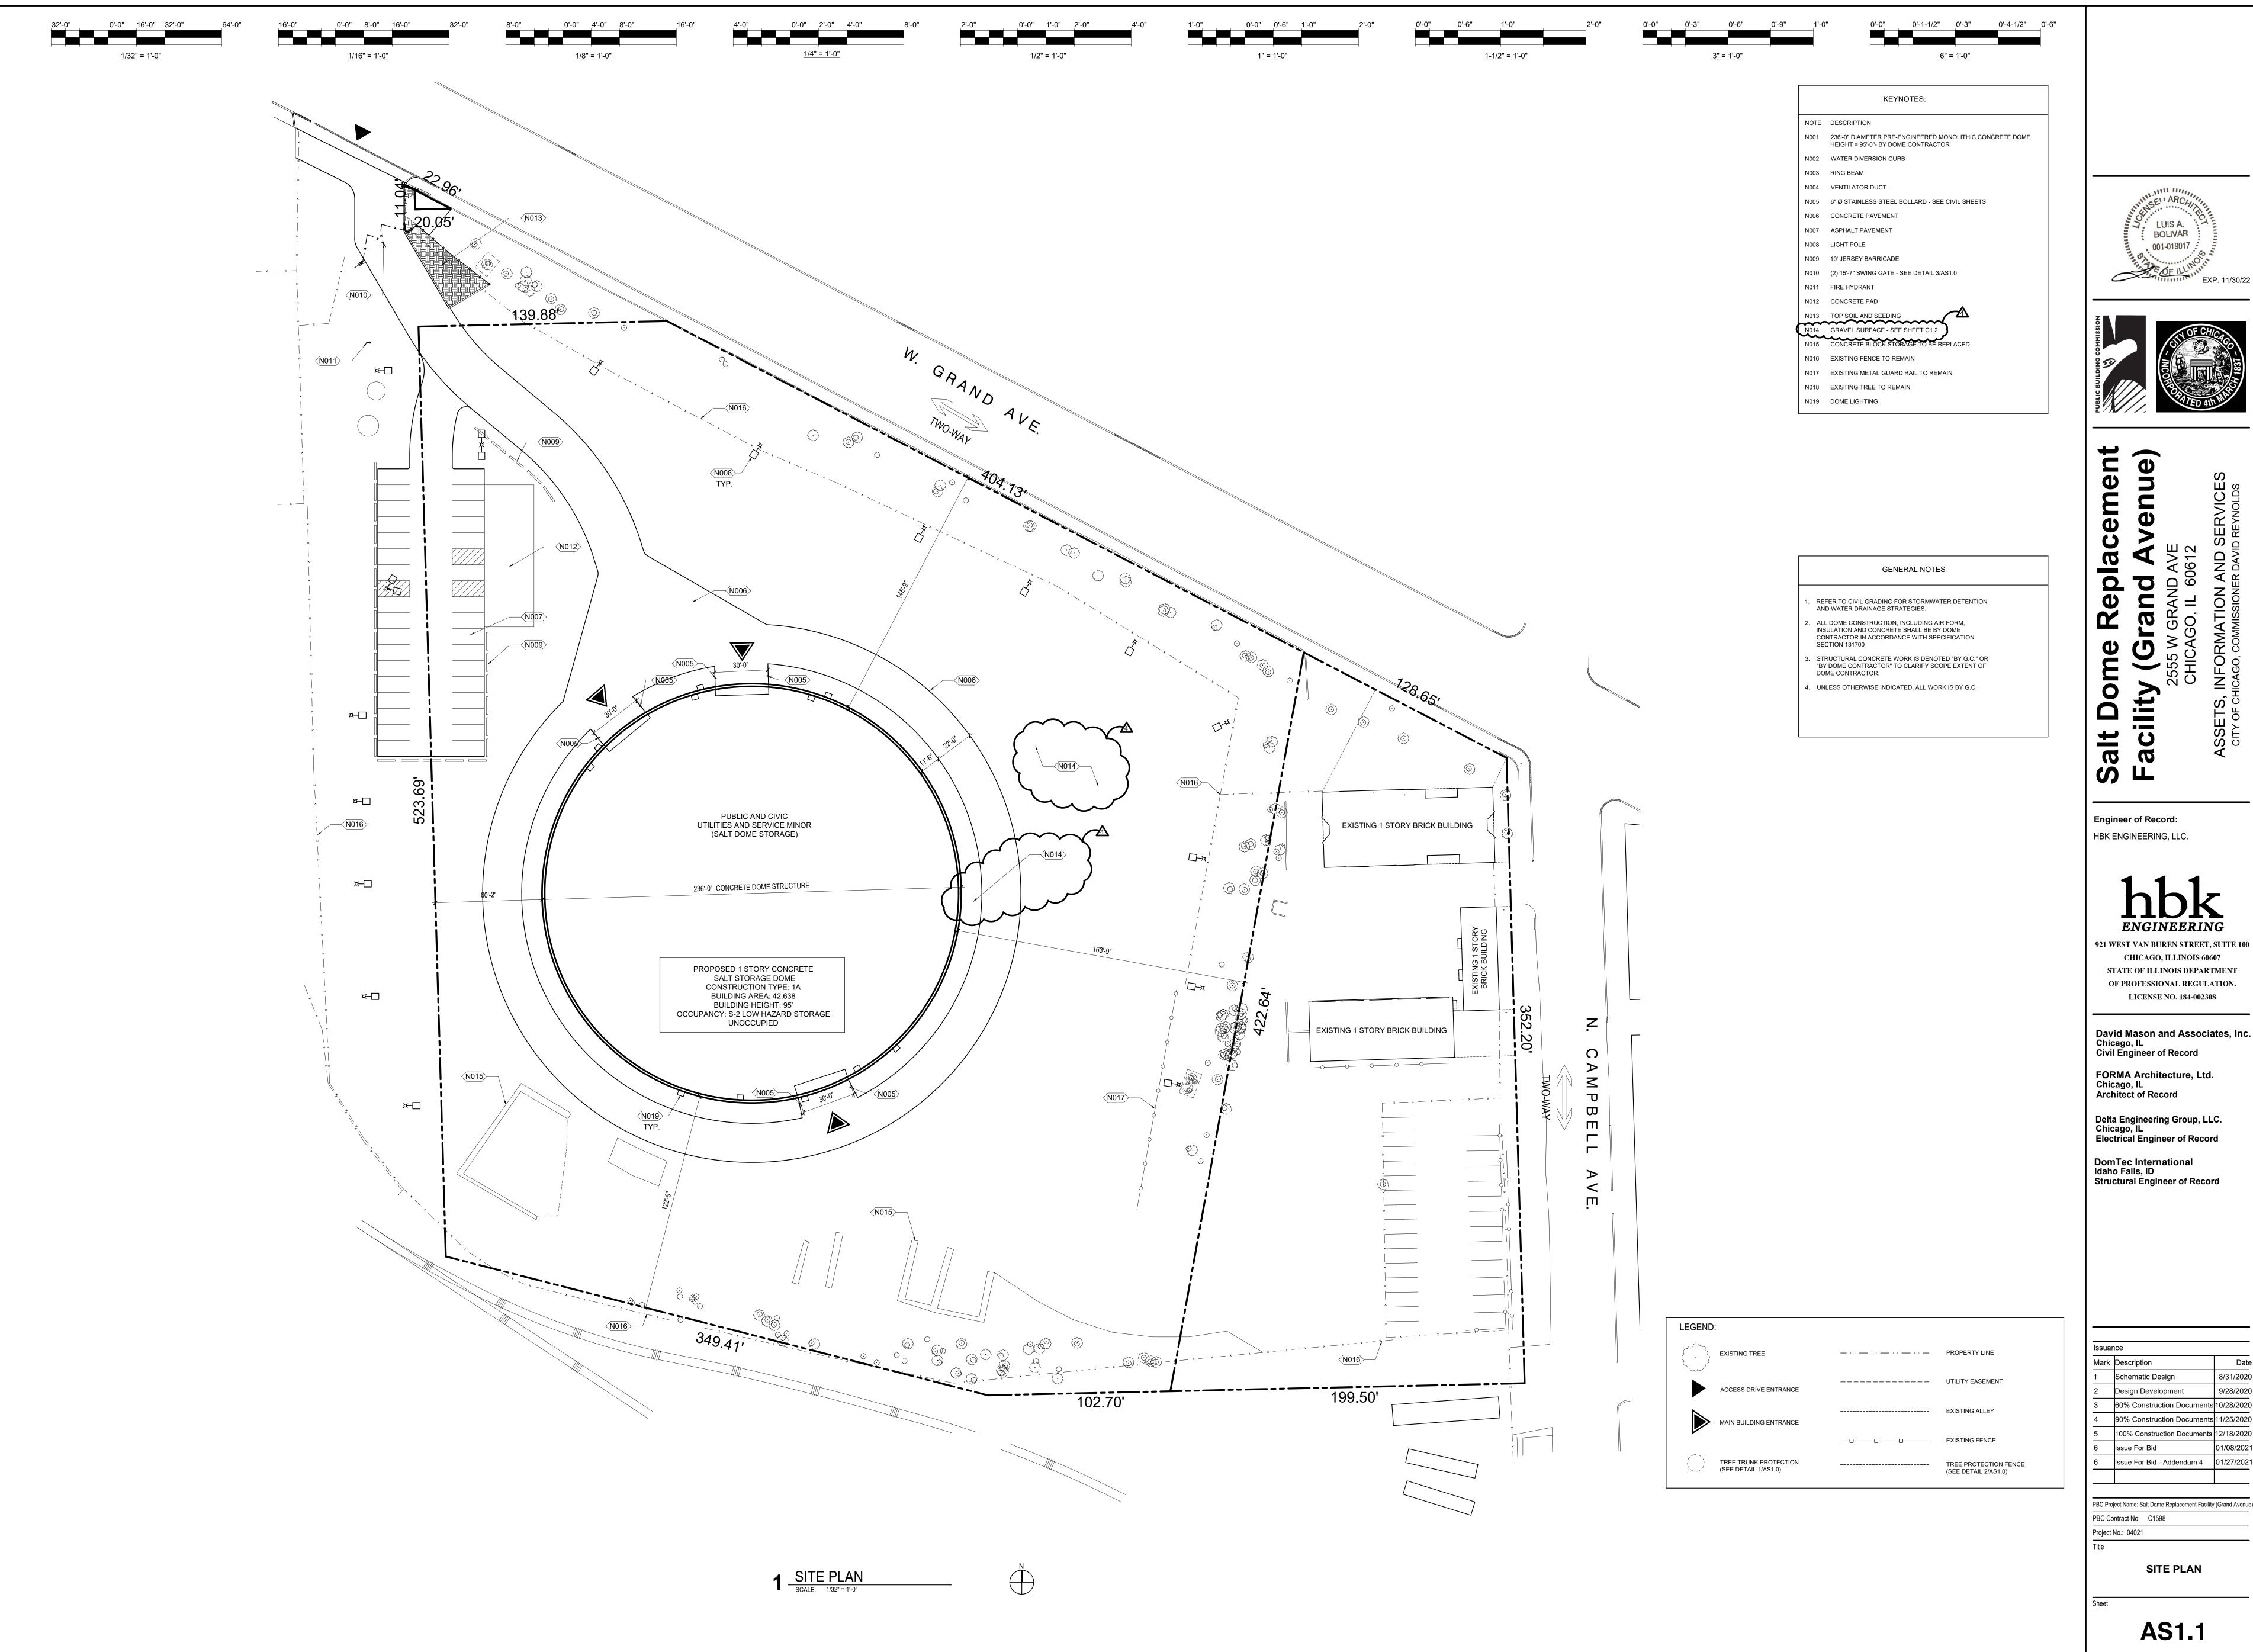

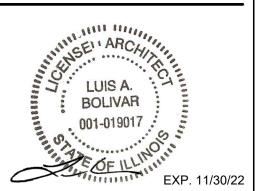








921 WEST VAN BUREN STREET, SUITE 100 STATE OF ILLINOIS DEPARTMENT OF PROFESSIONAL REGULATION.

Issuai	nce	
Mark	Description	Date
1	Schematic Design	8/31/2020
2	Design Development	9/28/2020
3	60% Construction Documents	10/28/2020
4	90% Construction Documents	11/25/2020
5	100% Construction Documents	12/18/2020
6	Issue For Bid	01/08/2021
6	Issue For Bid - Addendum 4	01/27/2021

PBC Project Name: Salt Dome Replacement Facility (Grand Avenue

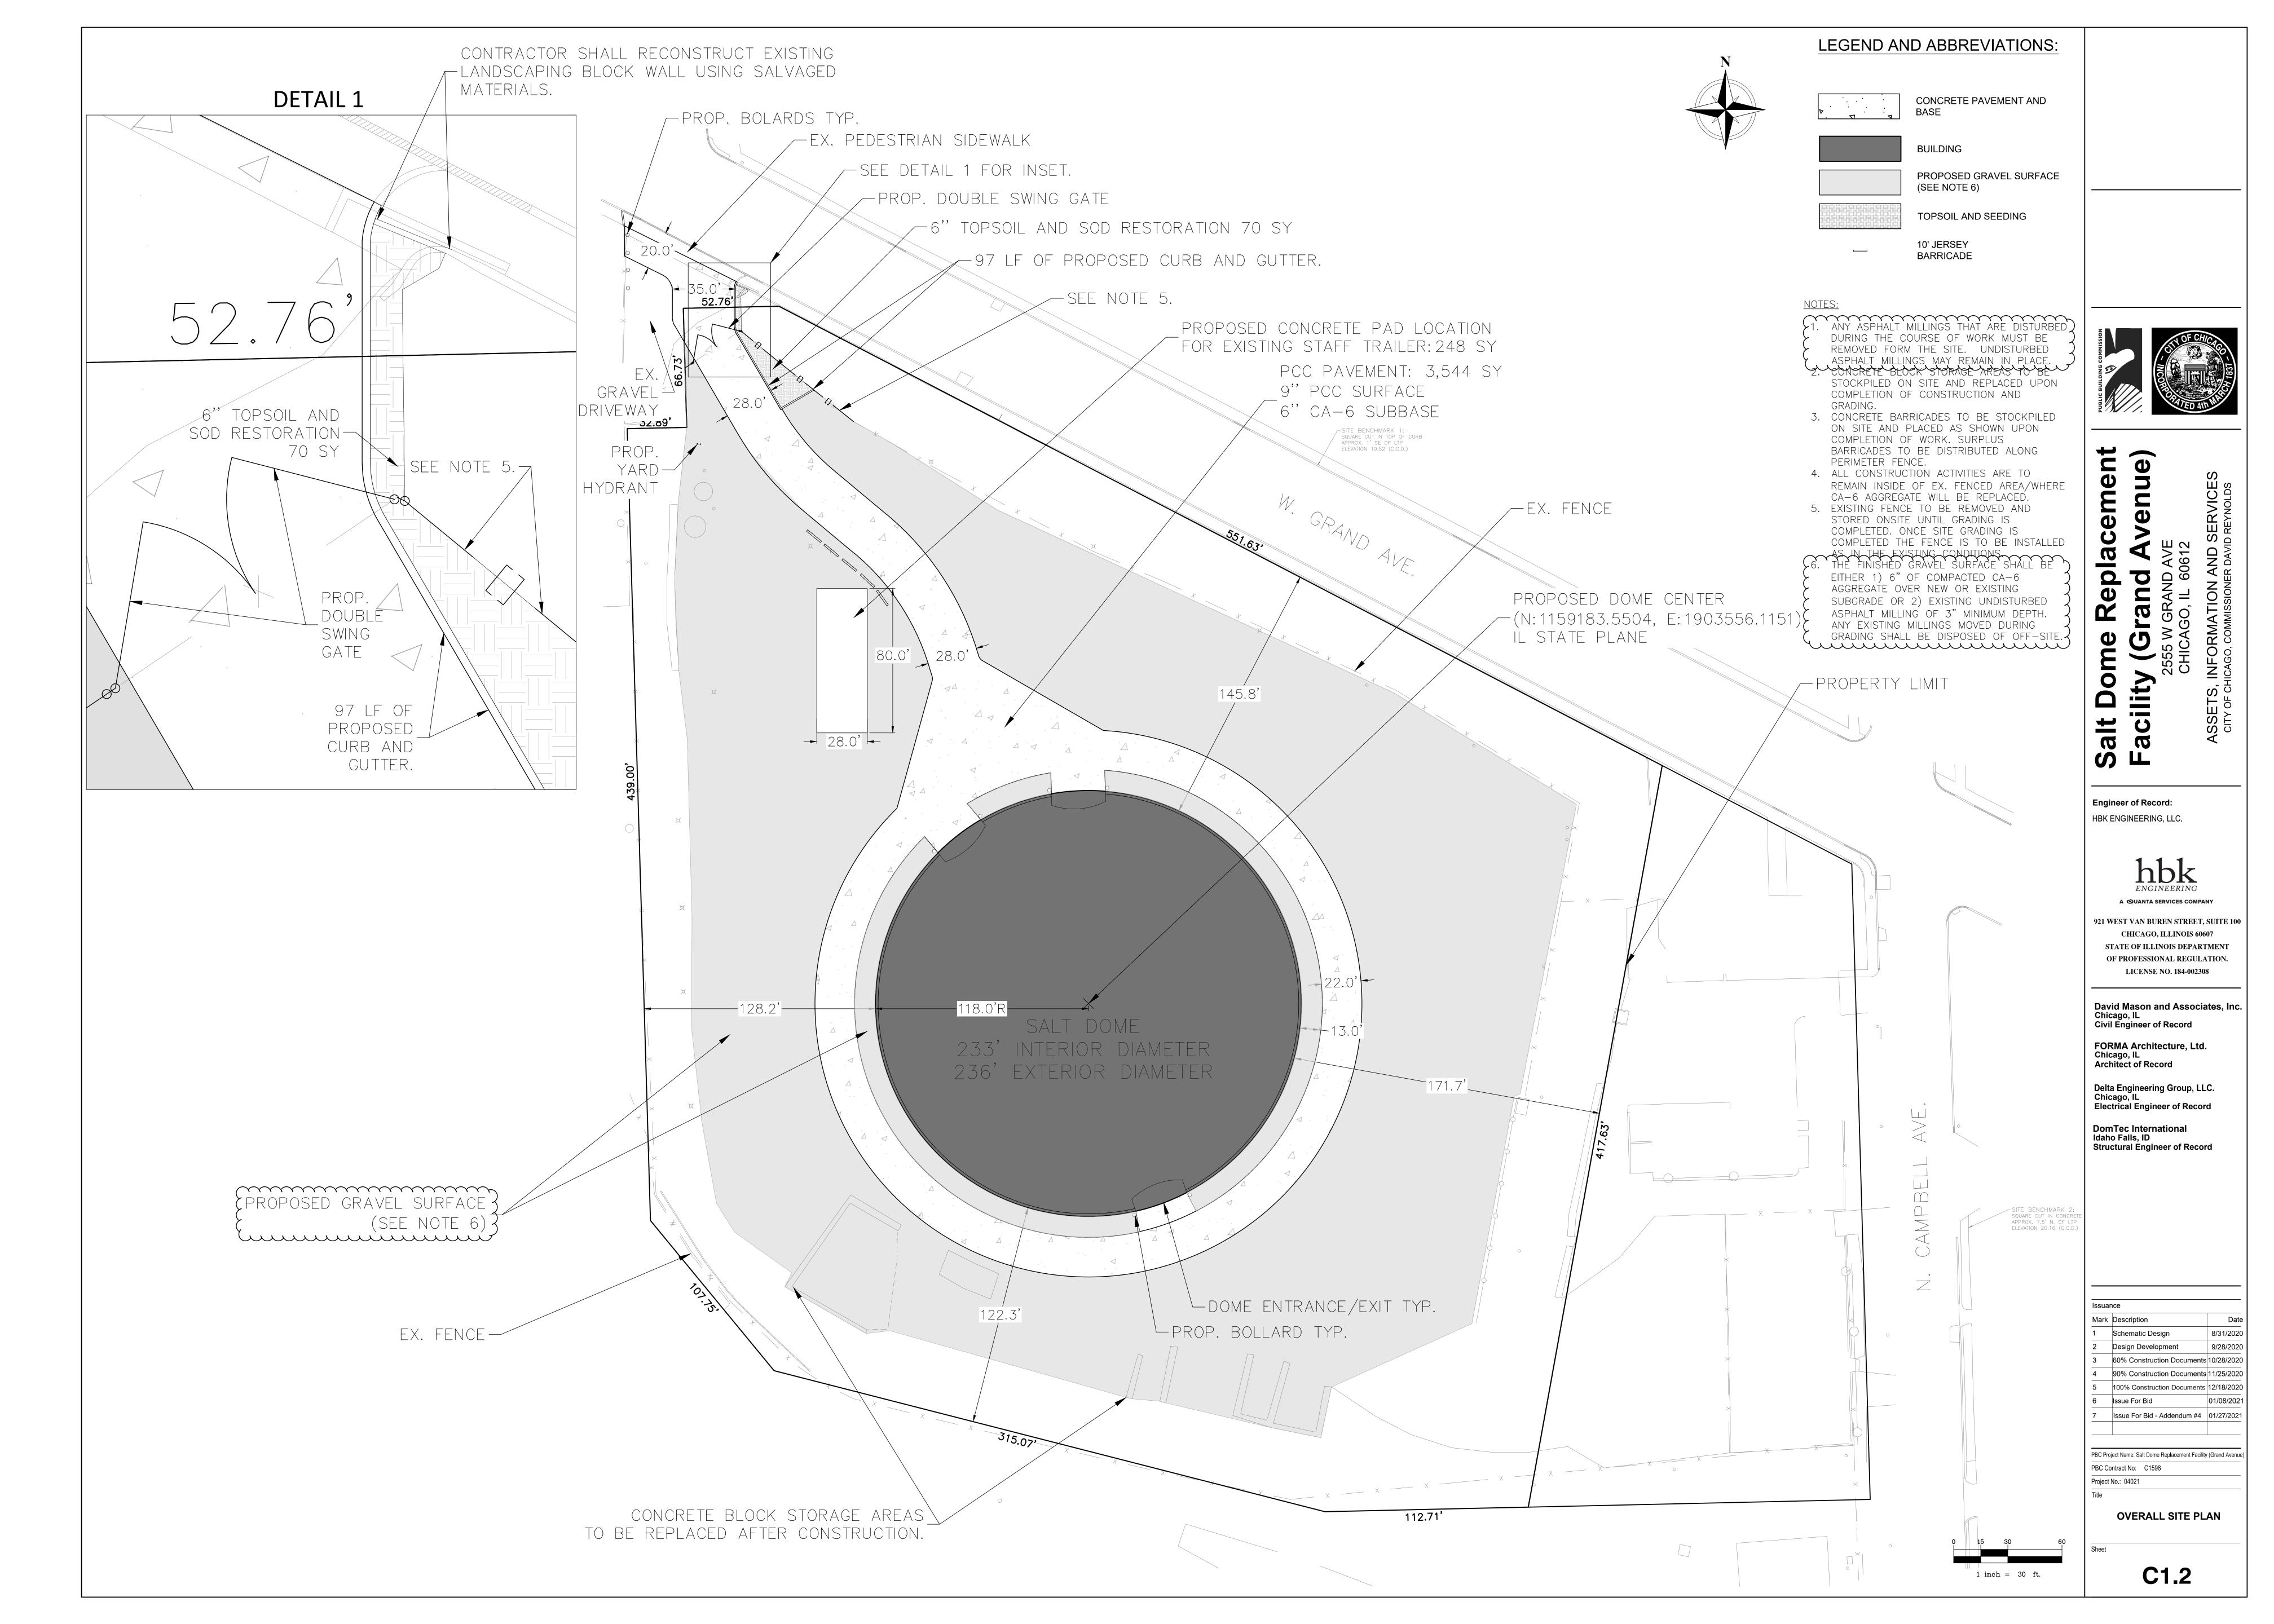

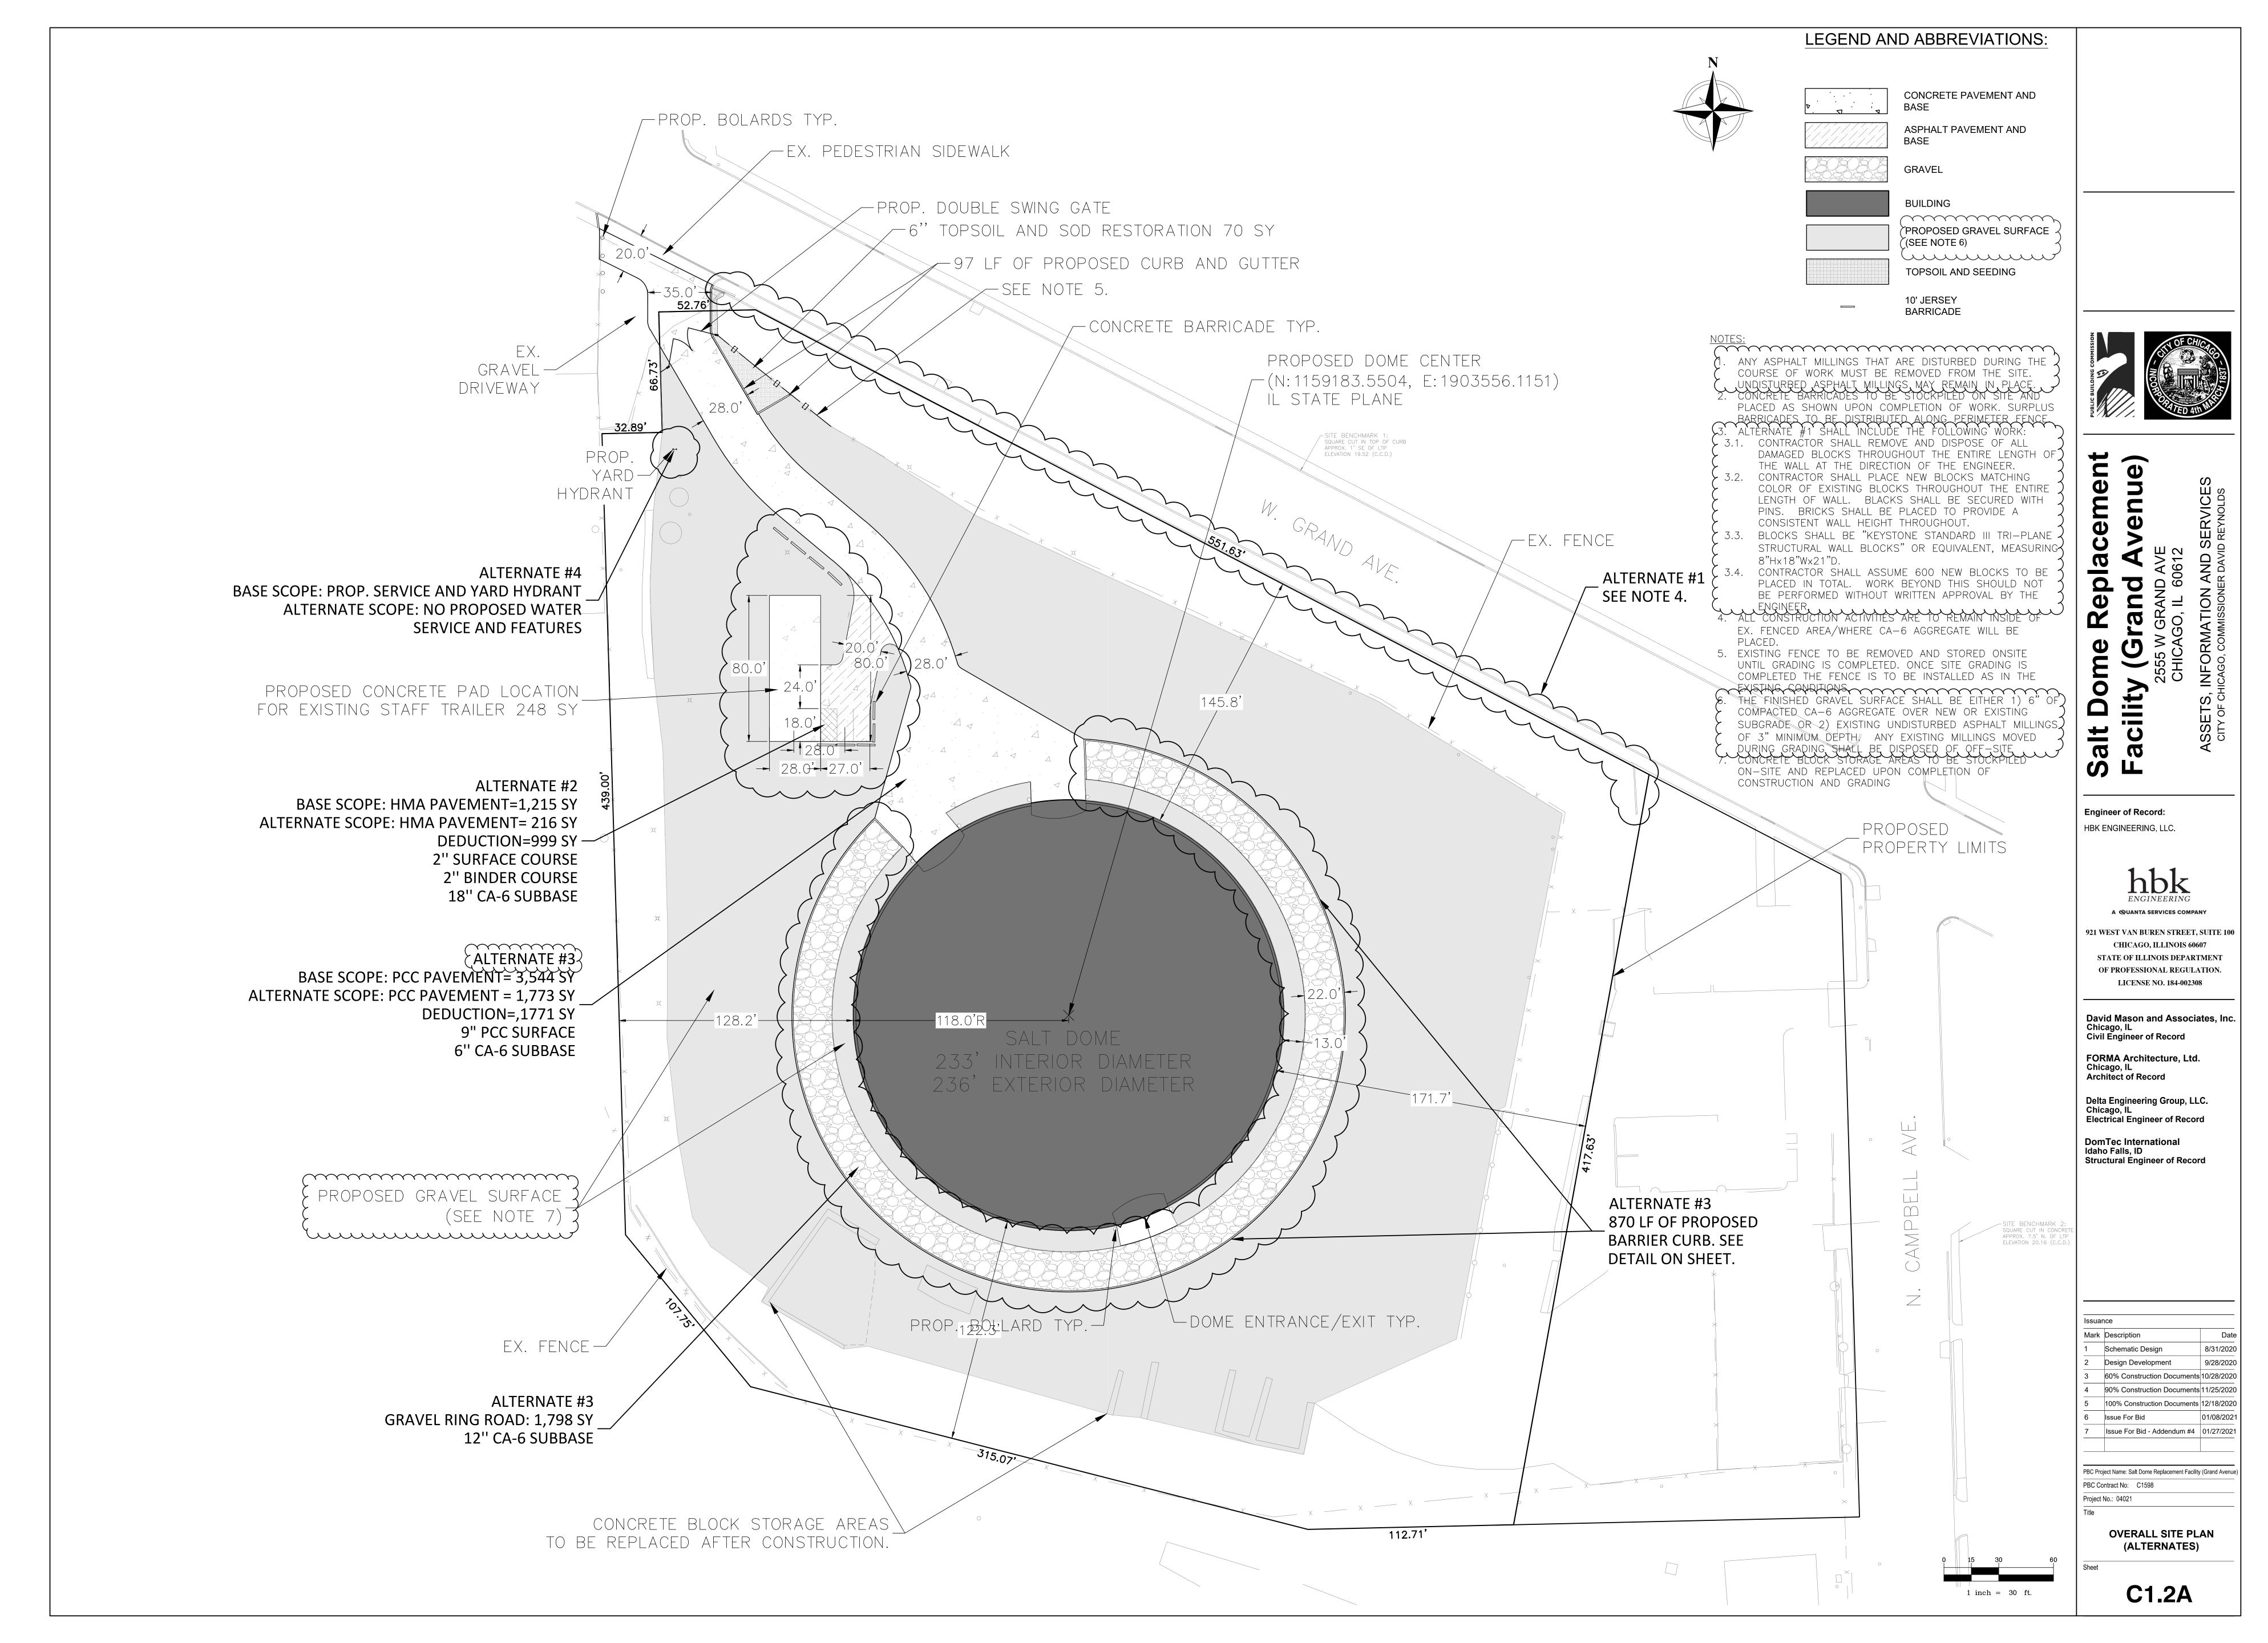

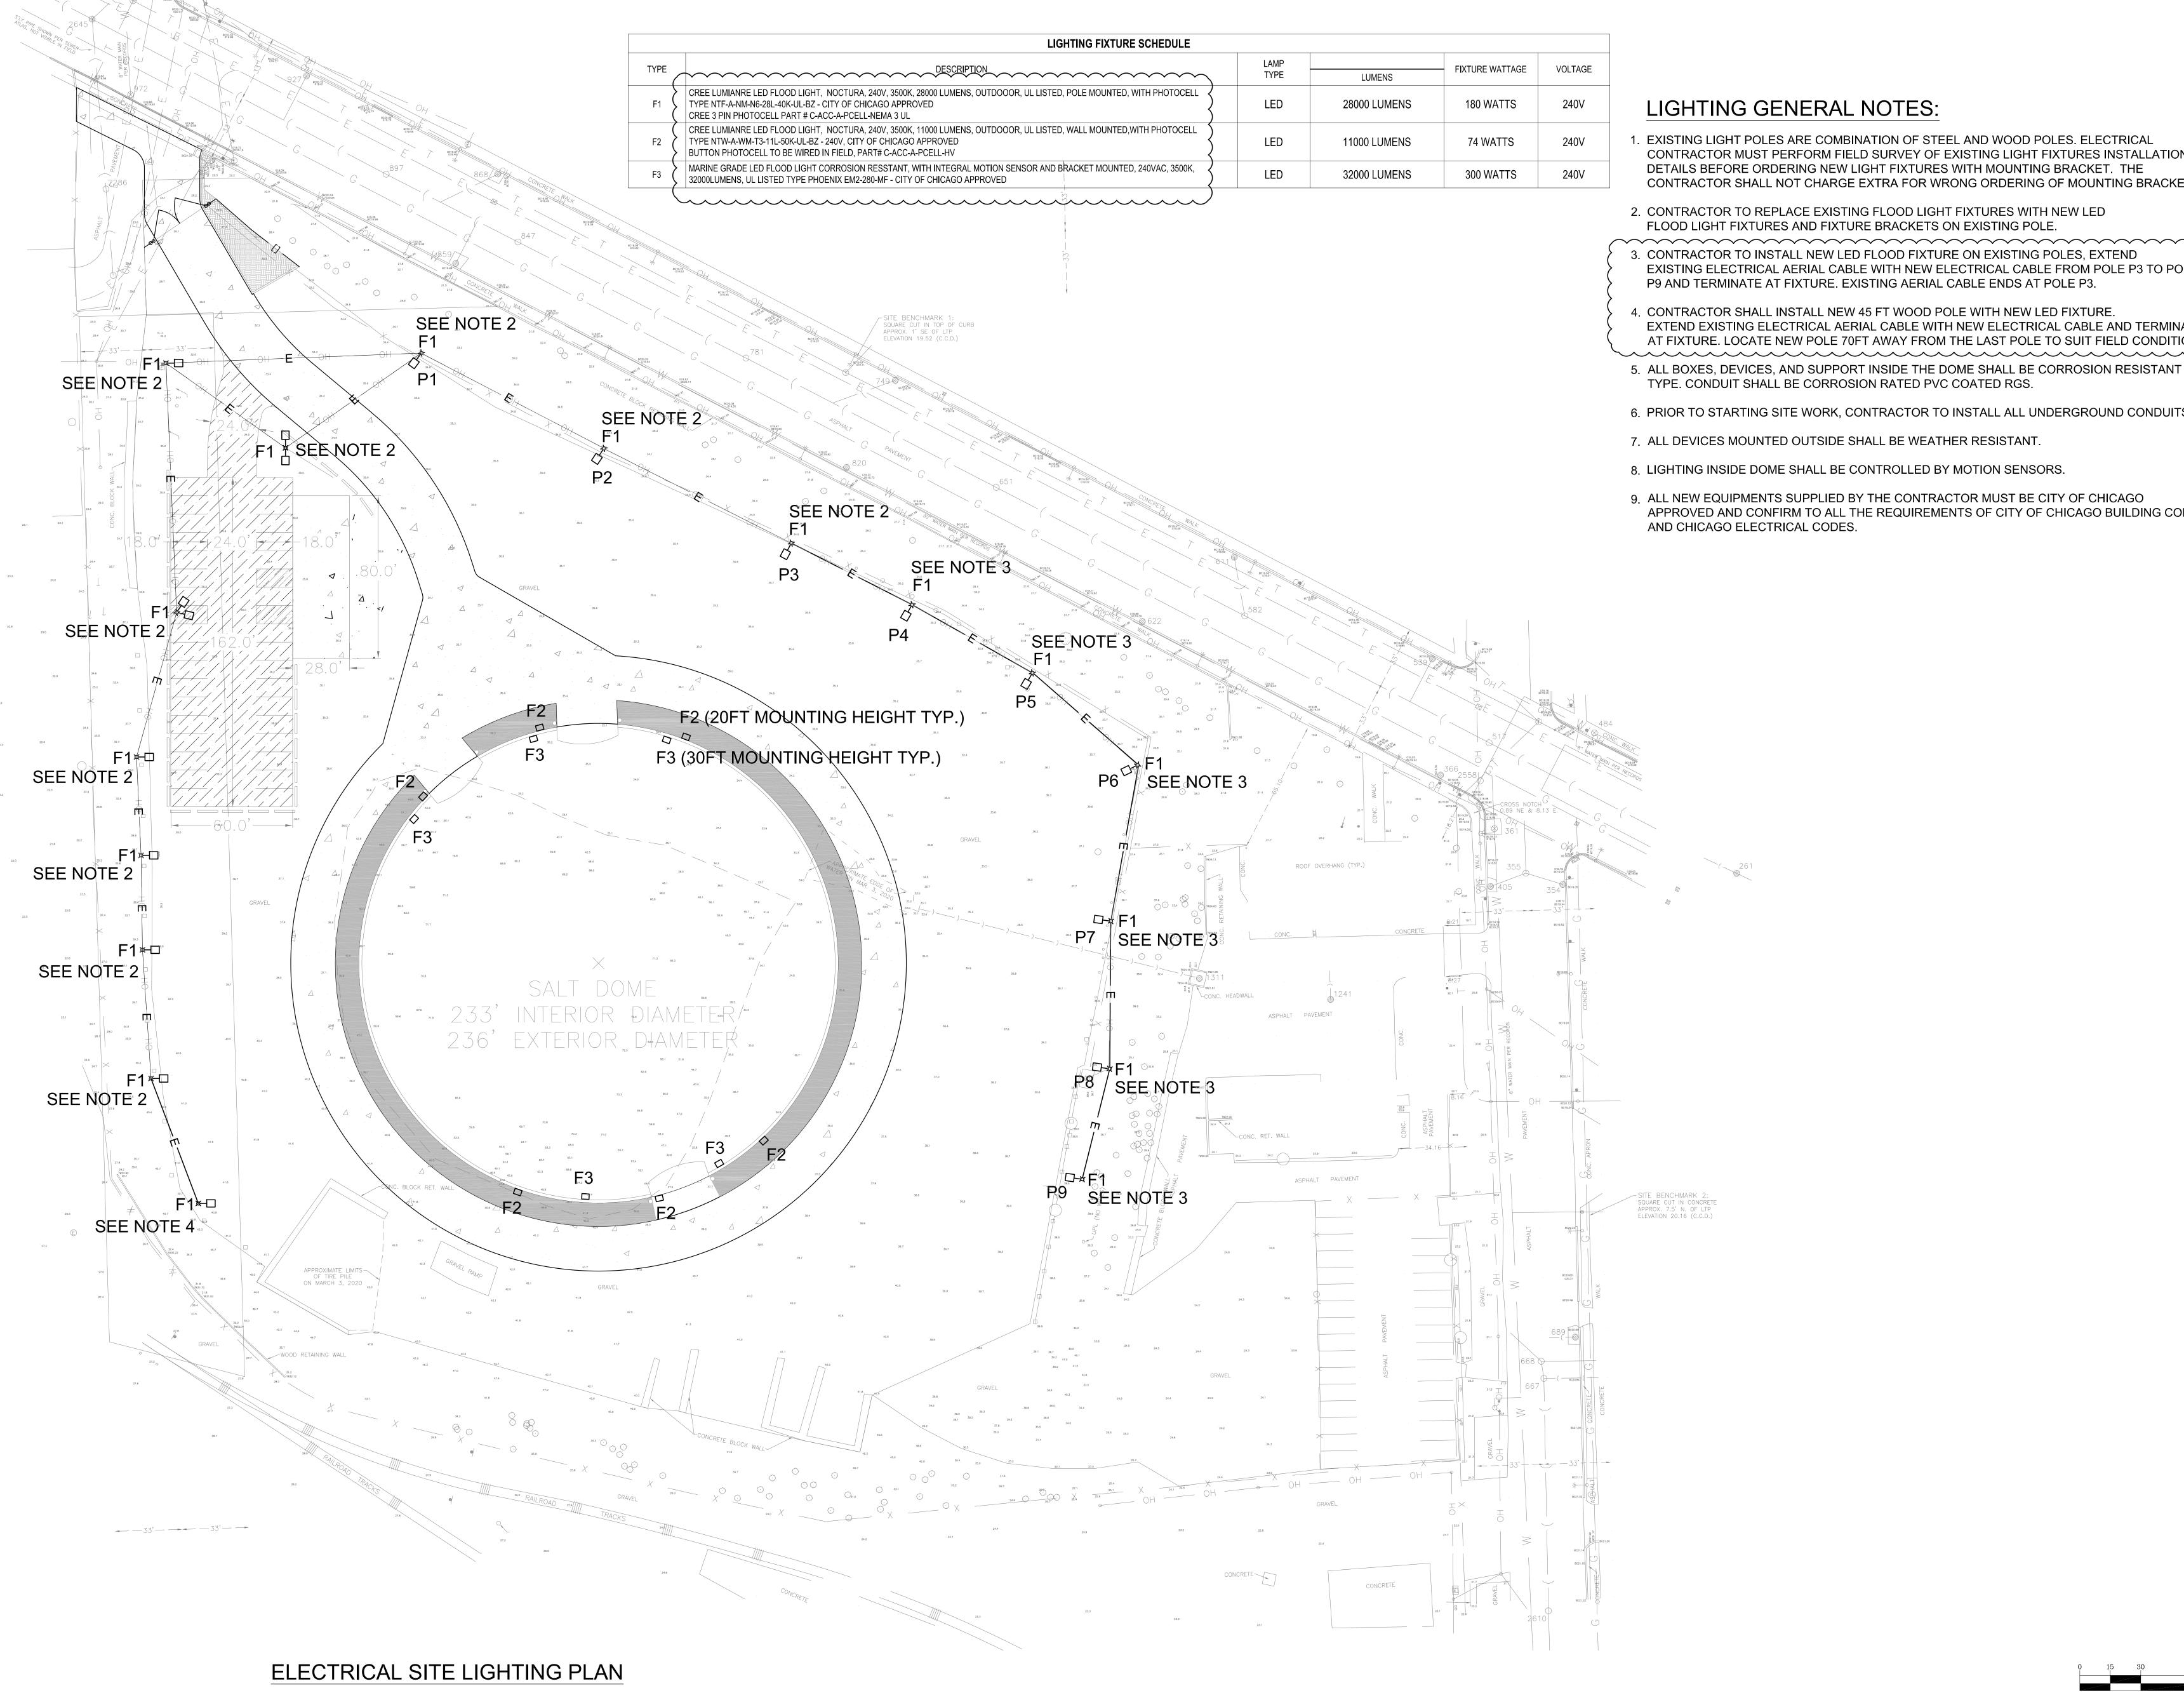



- 1. EXISTING LIGHT POLES ARE COMBINATION OF STEEL AND WOOD POLES. ELECTRICAL CONTRACTOR MUST PERFORM FIELD SURVEY OF EXISTING LIGHT FIXTURES INSTALLATION DETAILS BEFORE ORDERING NEW LIGHT FIXTURES WITH MOUNTING BRACKET. THE CONTRACTOR SHALL NOT CHARGE EXTRA FOR WRONG ORDERING OF MOUNTING BRACKET.
- 2. CONTRACTOR TO REPLACE EXISTING FLOOD LIGHT FIXTURES WITH NEW LED FLOOD LIGHT FIXTURES AND FIXTURE BRACKETS ON EXISTING POLE.
- 3. CONTRACTOR TO INSTALL NEW LED FLOOD FIXTURE ON EXISTING POLES, EXTEND EXISTING ELECTRICAL AERIAL CABLE WITH NEW ELECTRICAL CABLE FROM POLE P3 TO POLE P9 AND TERMINATE AT FIXTURE. EXISTING AERIAL CABLE ENDS AT POLE P3.
- EXTEND EXISTING ELECTRICAL AERIAL CABLE WITH NEW ELECTRICAL CABLE AND TERMINATE AT FIXTURE. LOCATE NEW POLE 70FT AWAY FROM THE LAST POLE TO SUIT FIELD CONDITIONS.
- 6. PRIOR TO STARTING SITE WORK, CONTRACTOR TO INSTALL ALL UNDERGROUND CONDUITS.
- 7. ALL DEVICES MOUNTED OUTSIDE SHALL BE WEATHER RESISTANT.
- 9. ALL NEW EQUIPMENTS SUPPLIED BY THE CONTRACTOR MUST BE CITY OF CHICAGO APPROVED AND CONFIRM TO ALL THE REQUIREMENTS OF CITY OF CHICAGO BUILDING CODES AND CHICAGO ELECTRICAL CODES.








Salt Do Facility

Engineer of Record: HBK ENGINEERING, LLC.

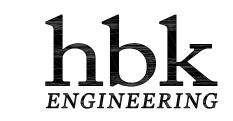

921 WEST VAN BUREN STREET, SUITE 100 CHICAGO, ILLINOIS 60607 STATE OF ILLINOIS DEPARTMENT OF PROFESSIONAL REGULATION. LICENSE NO. 184-002308

David Mason and Associates, Inc. Chicago, IL Civil Engineer of Record

FORMA Architecture, Ltd. Chicago, IL Architect of Record


Delta Engineering Group, LLC. Chicago, IL Electrical Engineer of Record

DomTec International Idaho Falls, ID Structural Engineer of Record

Issuance								
Mark	Description	Date						
1	Schematic Design	8/31/2020						
2	Design Development	9/28/2020						
3	60% Construction Documents	10/28/2020						
4	90% Construction Documents	11/25/2020						
5	100% Construction Documents	12/18/2020						
7	Issue For Bid - Addendum #4	01/27/2021						

PBC Contract No: C1598

E1.1

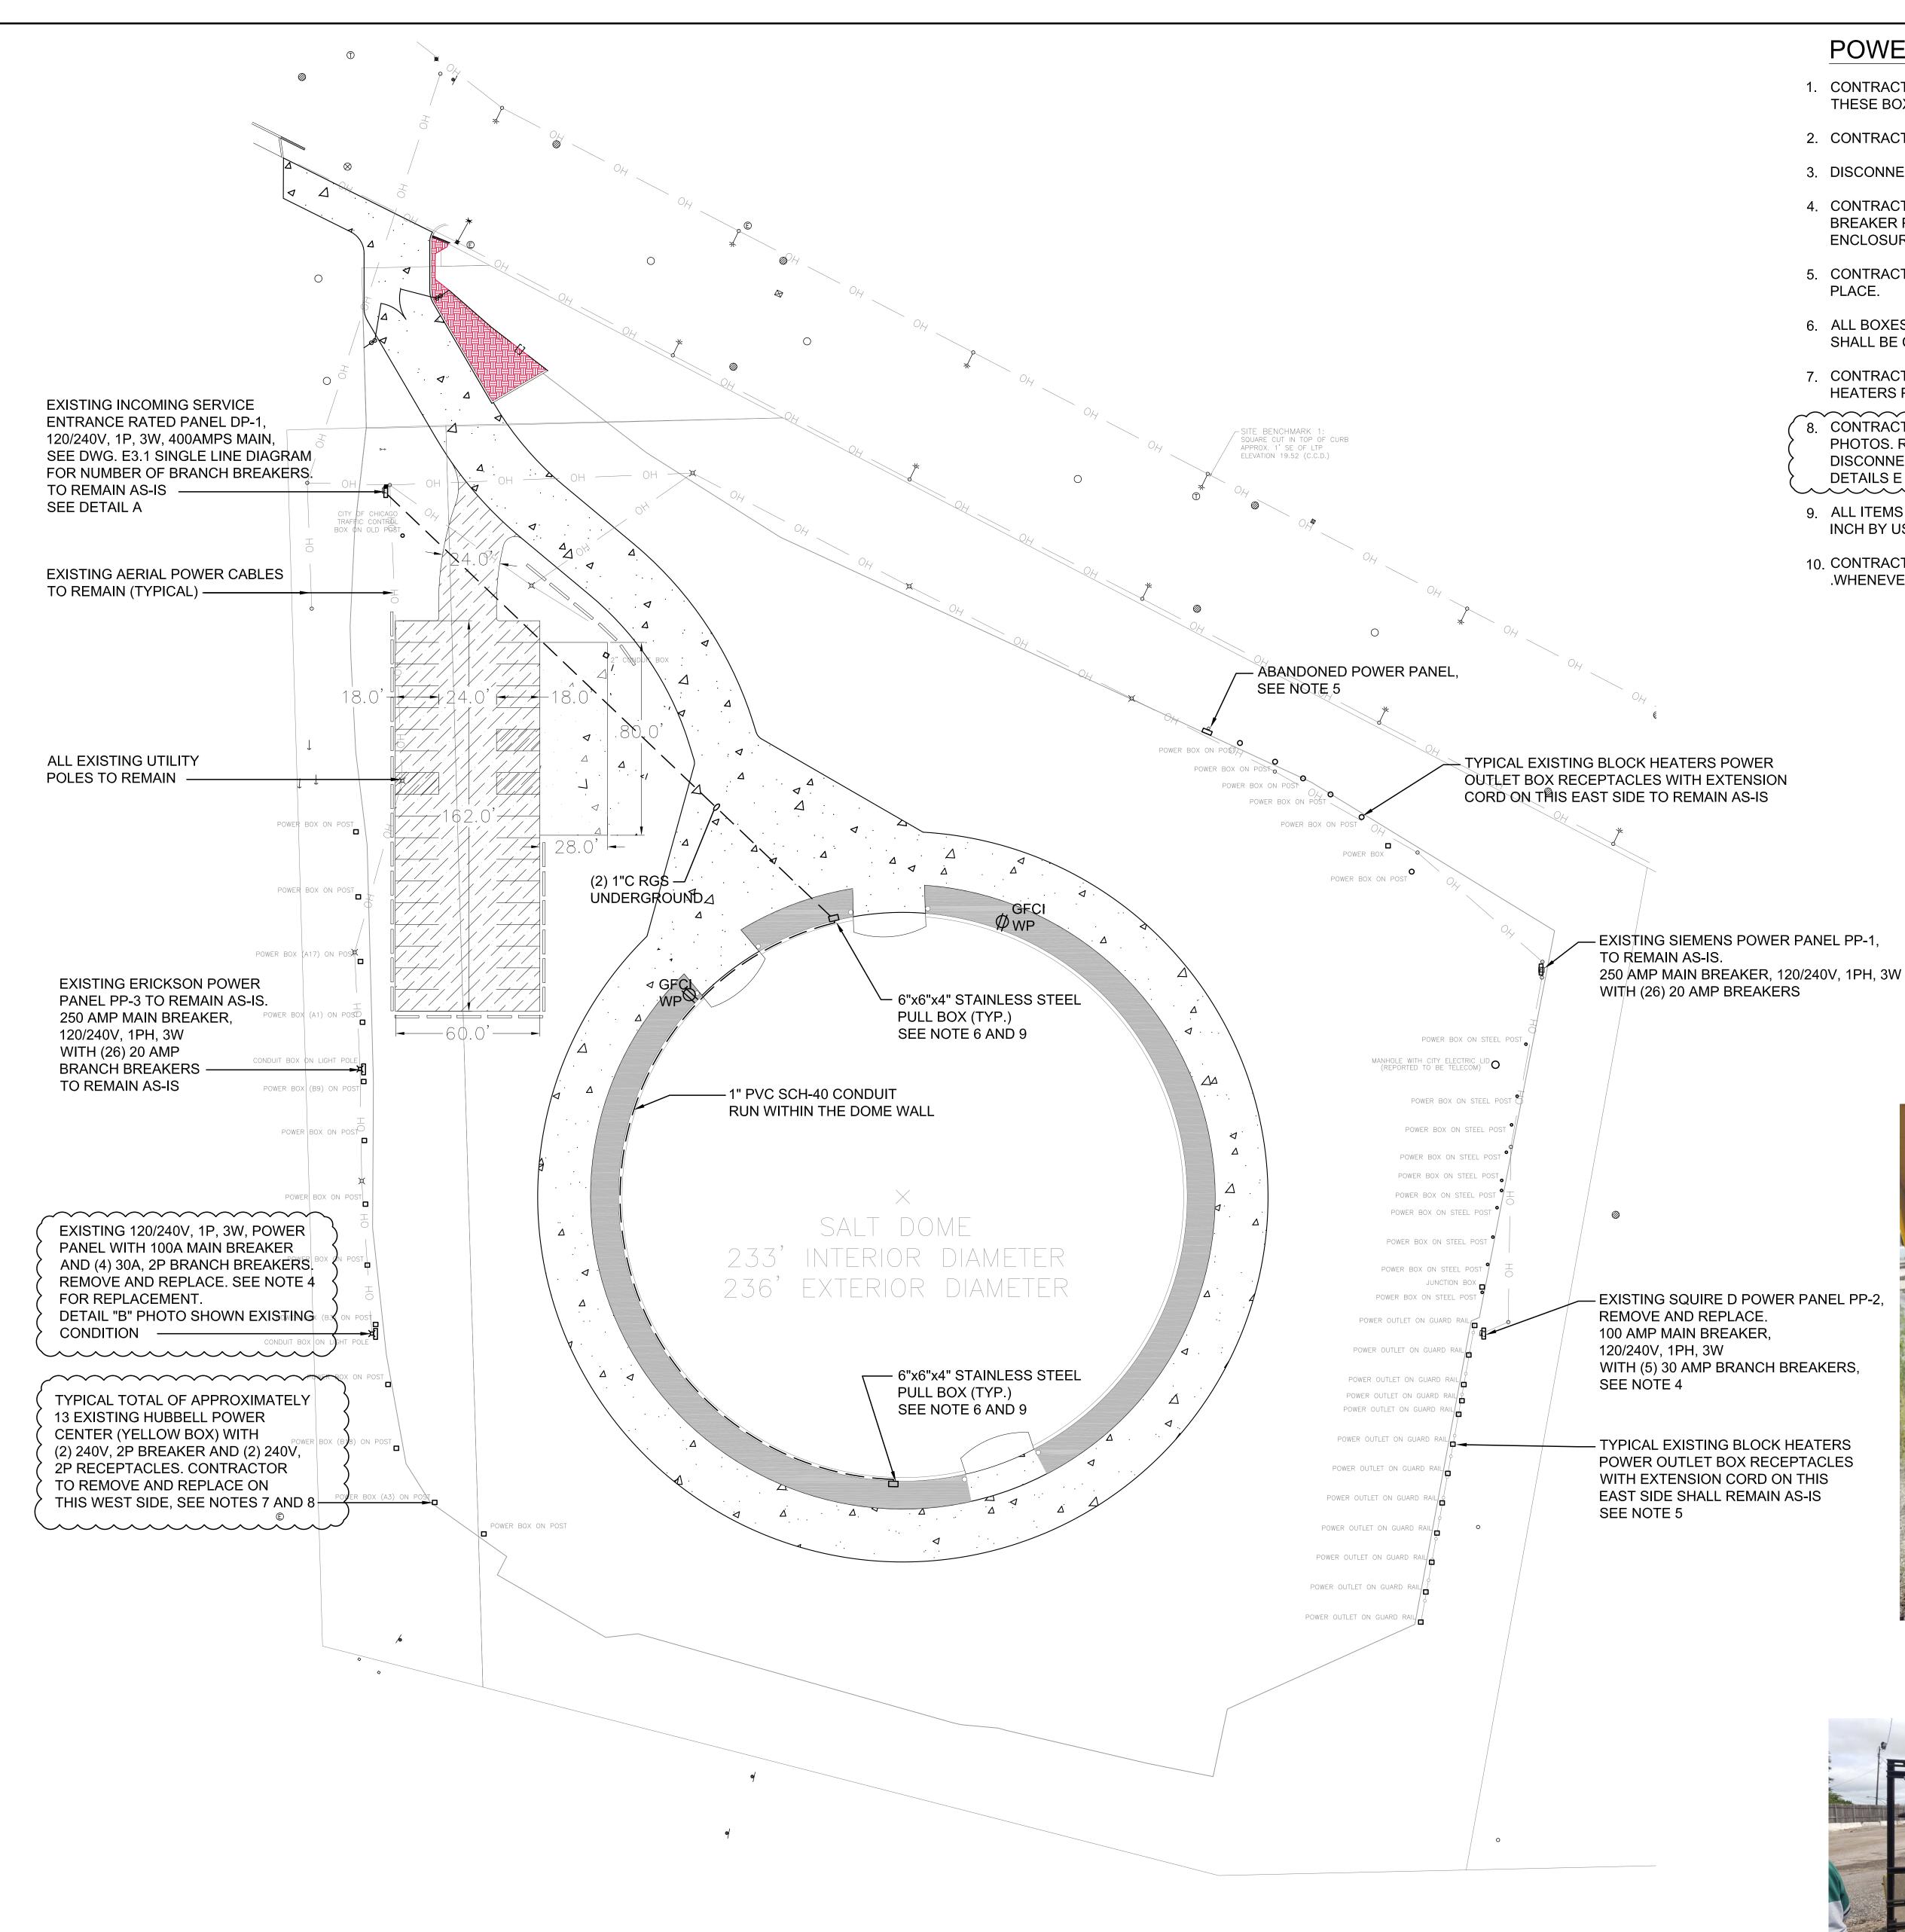

## POWER GENERAL NOTES:

- 1. CONTRACTOR TO DISCONNECT POWER CABLES CONNECTED TO HUBBELL POWER CENTER, THESE BOXES ARE LOCATED ON EAST SIDE OF EXISTING SALT PILE.
- 2. CONTRACTOR TO REMOVE ALL HUBBELL BOXES WHICH ARE YELLOW IN COLOR. SEE DETAIL "C" AND "D".
- 3. DISCONNECTED CABLES TO BE REUSED AFTER REPLACEMENT OF POWER CENTER BOXES.
- 4. CONTRACTOR TO DISCONNECT AND REMOVE EXISTING SQ. D, 100AMP PANEL. REPLACE WITH 100AMP MAIN BREAKER PANEL, NUMBER OF BRANCH BREAKERS AND SIZE OF BREAKERS SHALL REMAIN SAME. PANEL ENCLOSURE SHALL BE STAINLESS STEEL NEMA TYPE 3R.
- 5. CONTRACTOR TO DISCONNECT AT BOTH ENDS AND REMOVE ALL CABLES. ABANDON RACEWAY SYSTEM IN ITS
- 6. ALL BOXES, DEVICES, AND SUPPORT INSIDE THE DOME SHALL BE CORROSION RESISTANT TYPE. CONDUIT SHALL BE CORROSION RATED PVC COATED RGS.
- 7. CONTRACTOR MUST VISIT TO SURVEY NUMBER OF EXISTING LIGHT FIXTURES AND EXISTING ENGINE BLOCK HEATERS POWER OUTLET BOXES BY HUBBELL
- CONTRACTOR TO REPLACE APPROXIMATELY 13 HUBBELL POWER BOXES, SHOWN IN DETAIL "C" AND "D"
- 9. ALL ITEMS MOUNTED ON DOME STRUCTURE SHALL BE OFFSET FROM THE STRUCTURE A MINIMUM OF ONE (1) INCH BY USE OF STAINLESS STEEL C-CHANNEL
- 10. CONTRACTOR SHALL RECONNECT EXISTING POWER SUPPLY TO EXISTING TRAILERS, .WHENEVER TRAILERS WILL BE REPLACED OR RELOCATE.



PANEL TO BE REPLACED - DETAIL "B"

DETAIL "D"






DETAIL "C"



EXISTING PANEL DP-1 - DETAIL "A"

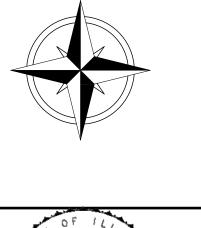





alt ac

**Engineer of Record:** HBK ENGINEERING, LLC.



921 WEST VAN BUREN STREET, SUITE 100 CHICAGO, ILLINOIS 60607 STATE OF ILLINOIS DEPARTMENT OF PROFESSIONAL REGULATION. LICENSE NO. 184-002308

David Mason and Associates, Inc. Chicago, IL Civil Engineer of Record

FORMA Architecture, Ltd. Chicago, IL Architect of Record

Delta Engineering Group, LLC. Chicago, IL Electrical Engineer of Record

DomTec International Idaho Falls, ID Structural Engineer of Record


Mark	Description	Date
1	Schematic Design	8/31/202
2	Design Development	9/28/202
3	60% Construction Documents	10/28/202
4	90% Construction Documents	11/25/202
5	100% Construction Documents	12/18/2020
7	Issue For Bid - Addendum #4	01/27/202
PBC Pro	ject Name: Salt Dome Replacement Facility	(Grand Aver

SITE POWER PLAN

E1.2

ELECTRICAL SITE POWER PLAN

1 inch = 30 ft.

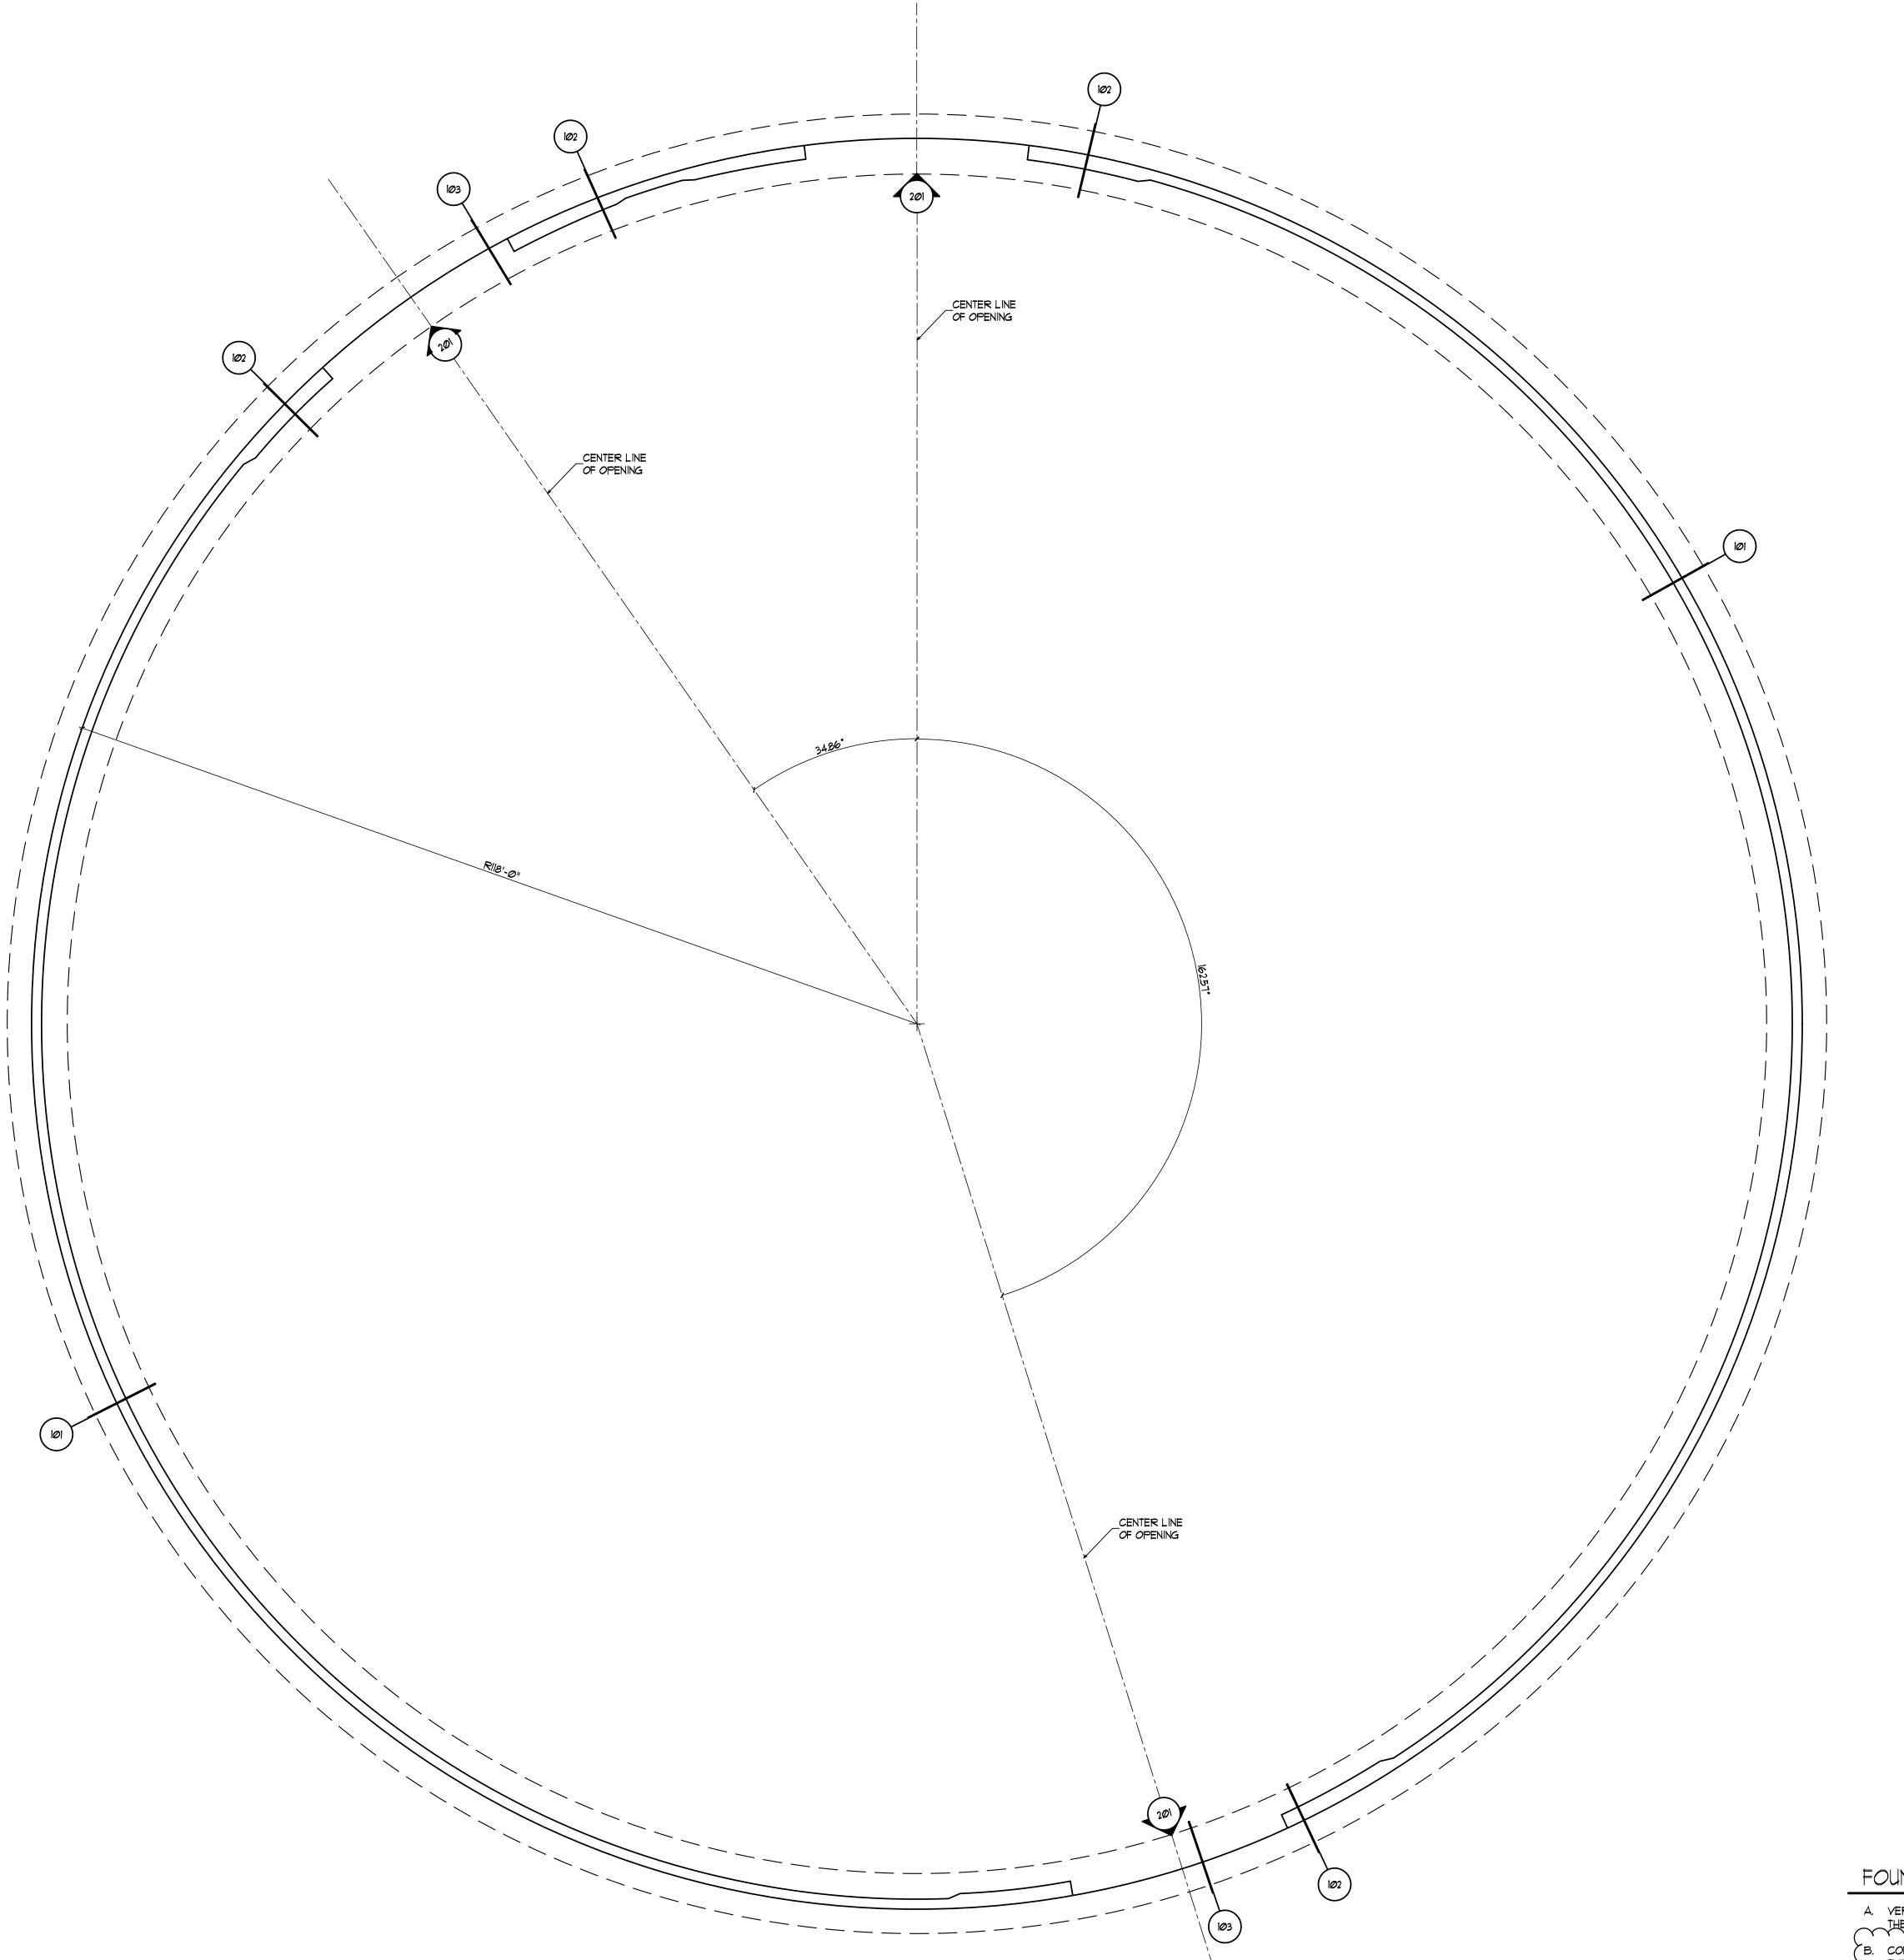





CO ATT MINES

SALT DOME
2555 W GRAND AVE

Engineer of Record:
HBK ENGINEERING, LLC.

hbk ENGINEERING A QUANTA SERVICES COMPANY

921 WEST VAN BUREN STREET, SUITE 100 CHICAGO, ILLINOIS 60607 STATE OF ILLINOIS DEPARTMENT OF PROFESSIONAL REGULATION. LICENSE NO. 184-002308

David Mason and Associates, Inc. Chicago, IL Civil Engineer of Record

FORMA Architecture, Ltd. Chicago, IL Architect of Record

Delta Engineering Group, LLC. Chicago, IL Electrical Engineer of Record

DomTec International
Idaho Falls, ID
Dome Contractor

ZZ Consulting
Shelley, ID
Dome Structural Engineer of Record

Issuance							
Mark	Description	Date					
1	Schematic Design	8/31/2020					
2	Design Development	9/28/2020					
3	60% Construction Documents	10/28/2020					
4	Issue For Permit	11/20/2020					
6	Issue For Bid	1/8/2021					
7	Issue For Bid - Addendum 4	1/27/2021					

PBC Project Name: Grand Avenue Salt Dome
PBC Contract No: 00000
Project No.: 04021

FOUNDATION PLAN

S1.1

FOUNDATION PLAN NOTES


A. VERIFY ALL DIMENSIONS PRIOR TO CONSTRUCTION. RESOLVE DISCREPANCIES WITH THE ARCHITECT.


(B. CONCRETE SLAB SHALL BE 6" THICK OVER 24" PROPERLY COMPACTED DOT TYPE SUB BASE OVER PROPERLY COMPACTED SOIL. REINFORCE SLAB WITH \*4 BARS AT 12" o.c. EACH WAY CENTERED IN SLAB THICKNESS. MOISTEN BUT DO NOT SATURATE SOIL IMMEDIATELY BENEATH SLAB PRIOR TO CONCRETE PLACEMENT.

SATURATE SOIL IMMEDIATELY BENEATH SLAB PRIOR TO CONCRETE PLACEMENT. .

FOUNDATION PLAN

SCALE: 3/32" = 1'-Ø"

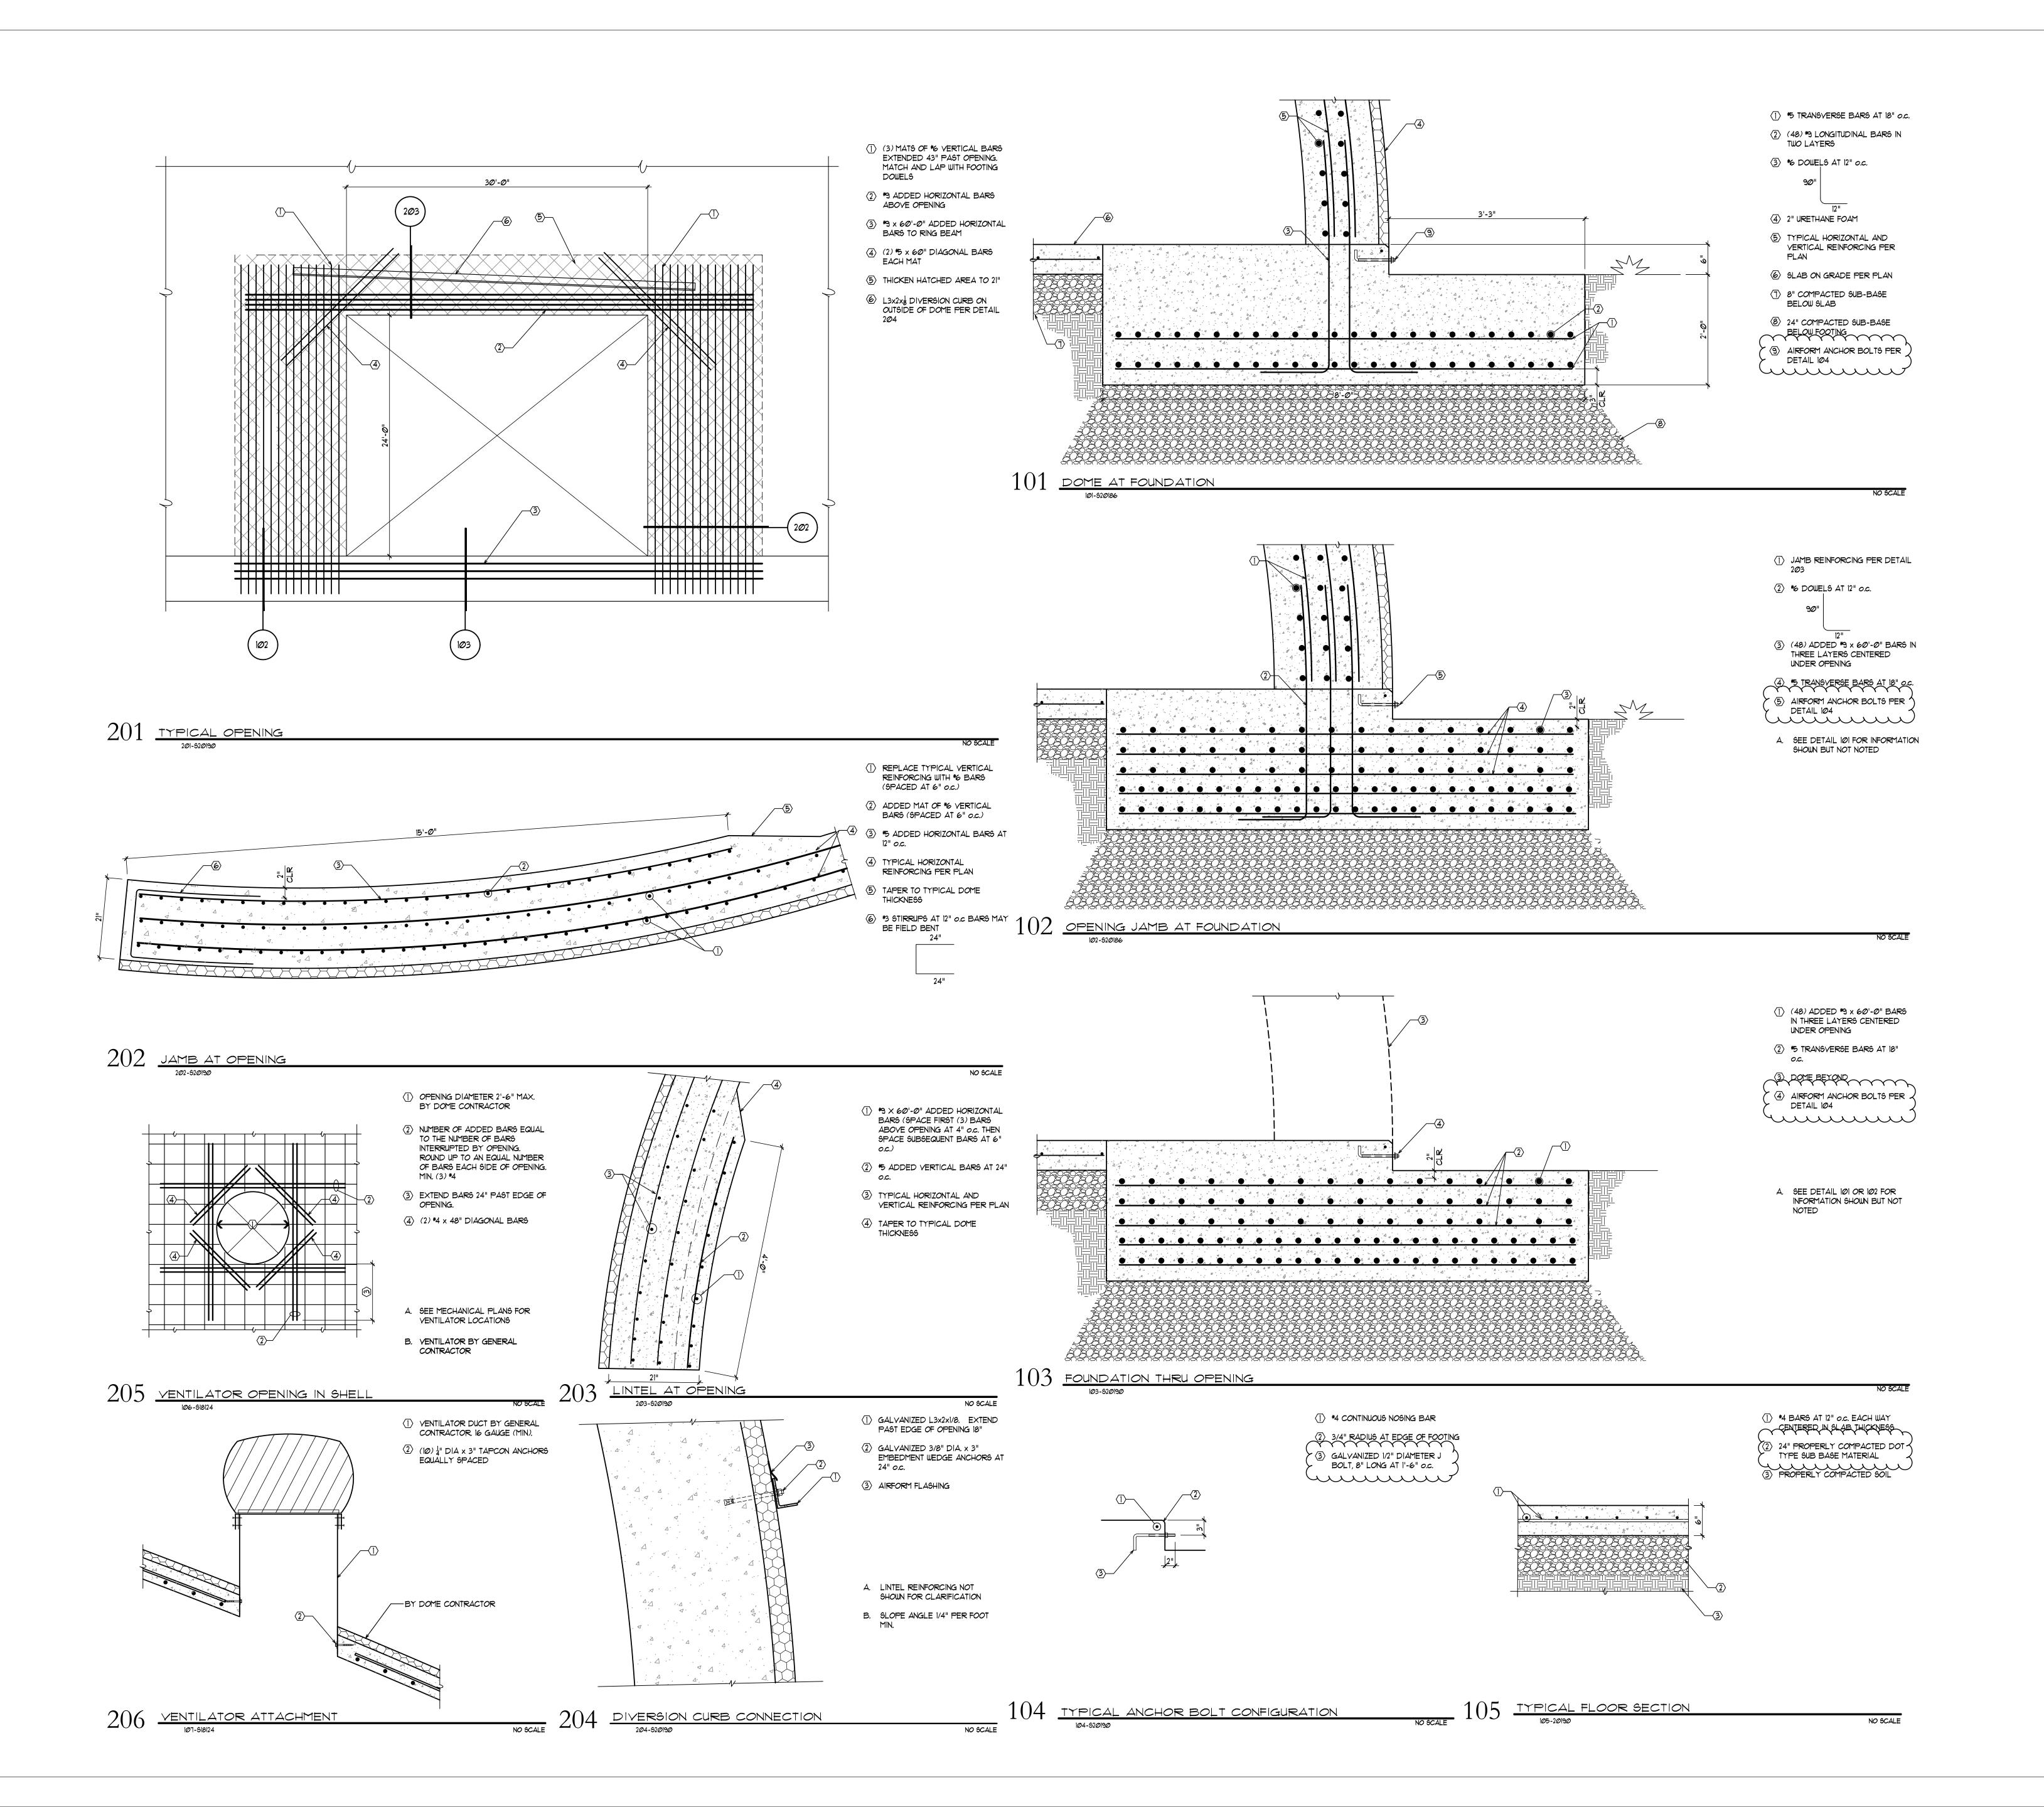

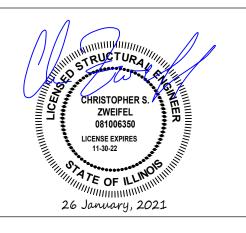



T DOME
V GRAND AVE
AGO, IL 60612

Engineer of Record:
HBK ENGINEERING, LLC.

C) S

hbk
ENGINEERING

A QUANTA SERVICES COMPANY

921 WEST VAN BUREN STREET, SUITE 100 CHICAGO, ILLINOIS 60607 STATE OF ILLINOIS DEPARTMENT OF PROFESSIONAL REGULATION. LICENSE NO. 184-002308

David Mason and Associates, Inc. Chicago, IL Civil Engineer of Record

FORMA Architecture, Ltd. Chicago, IL Architect of Record

Delta Engineering Group, LLC.
Chicago, IL
Electrical Engineer of Record

DomTec International

Dome Contractor

ZZ Consulting
Shelley, ID
Dome Structural Engineer of Record

Idaho Falls, ID


Mark	Description	D
1	Schematic Design	8/31/20
2	Design Development	9/28/20
3	60% Construction Documents	10/28/20
4	Issue For Permit	11/20/20
6	Issue For Bid	1/8/202
7	Issue For Bid - Addendum 4	1/27/20

PBC Project Name: Grand Avenue Salt Dome
PBC Contract No: 00000

Project No.: 04021

DETAILS

S3.1

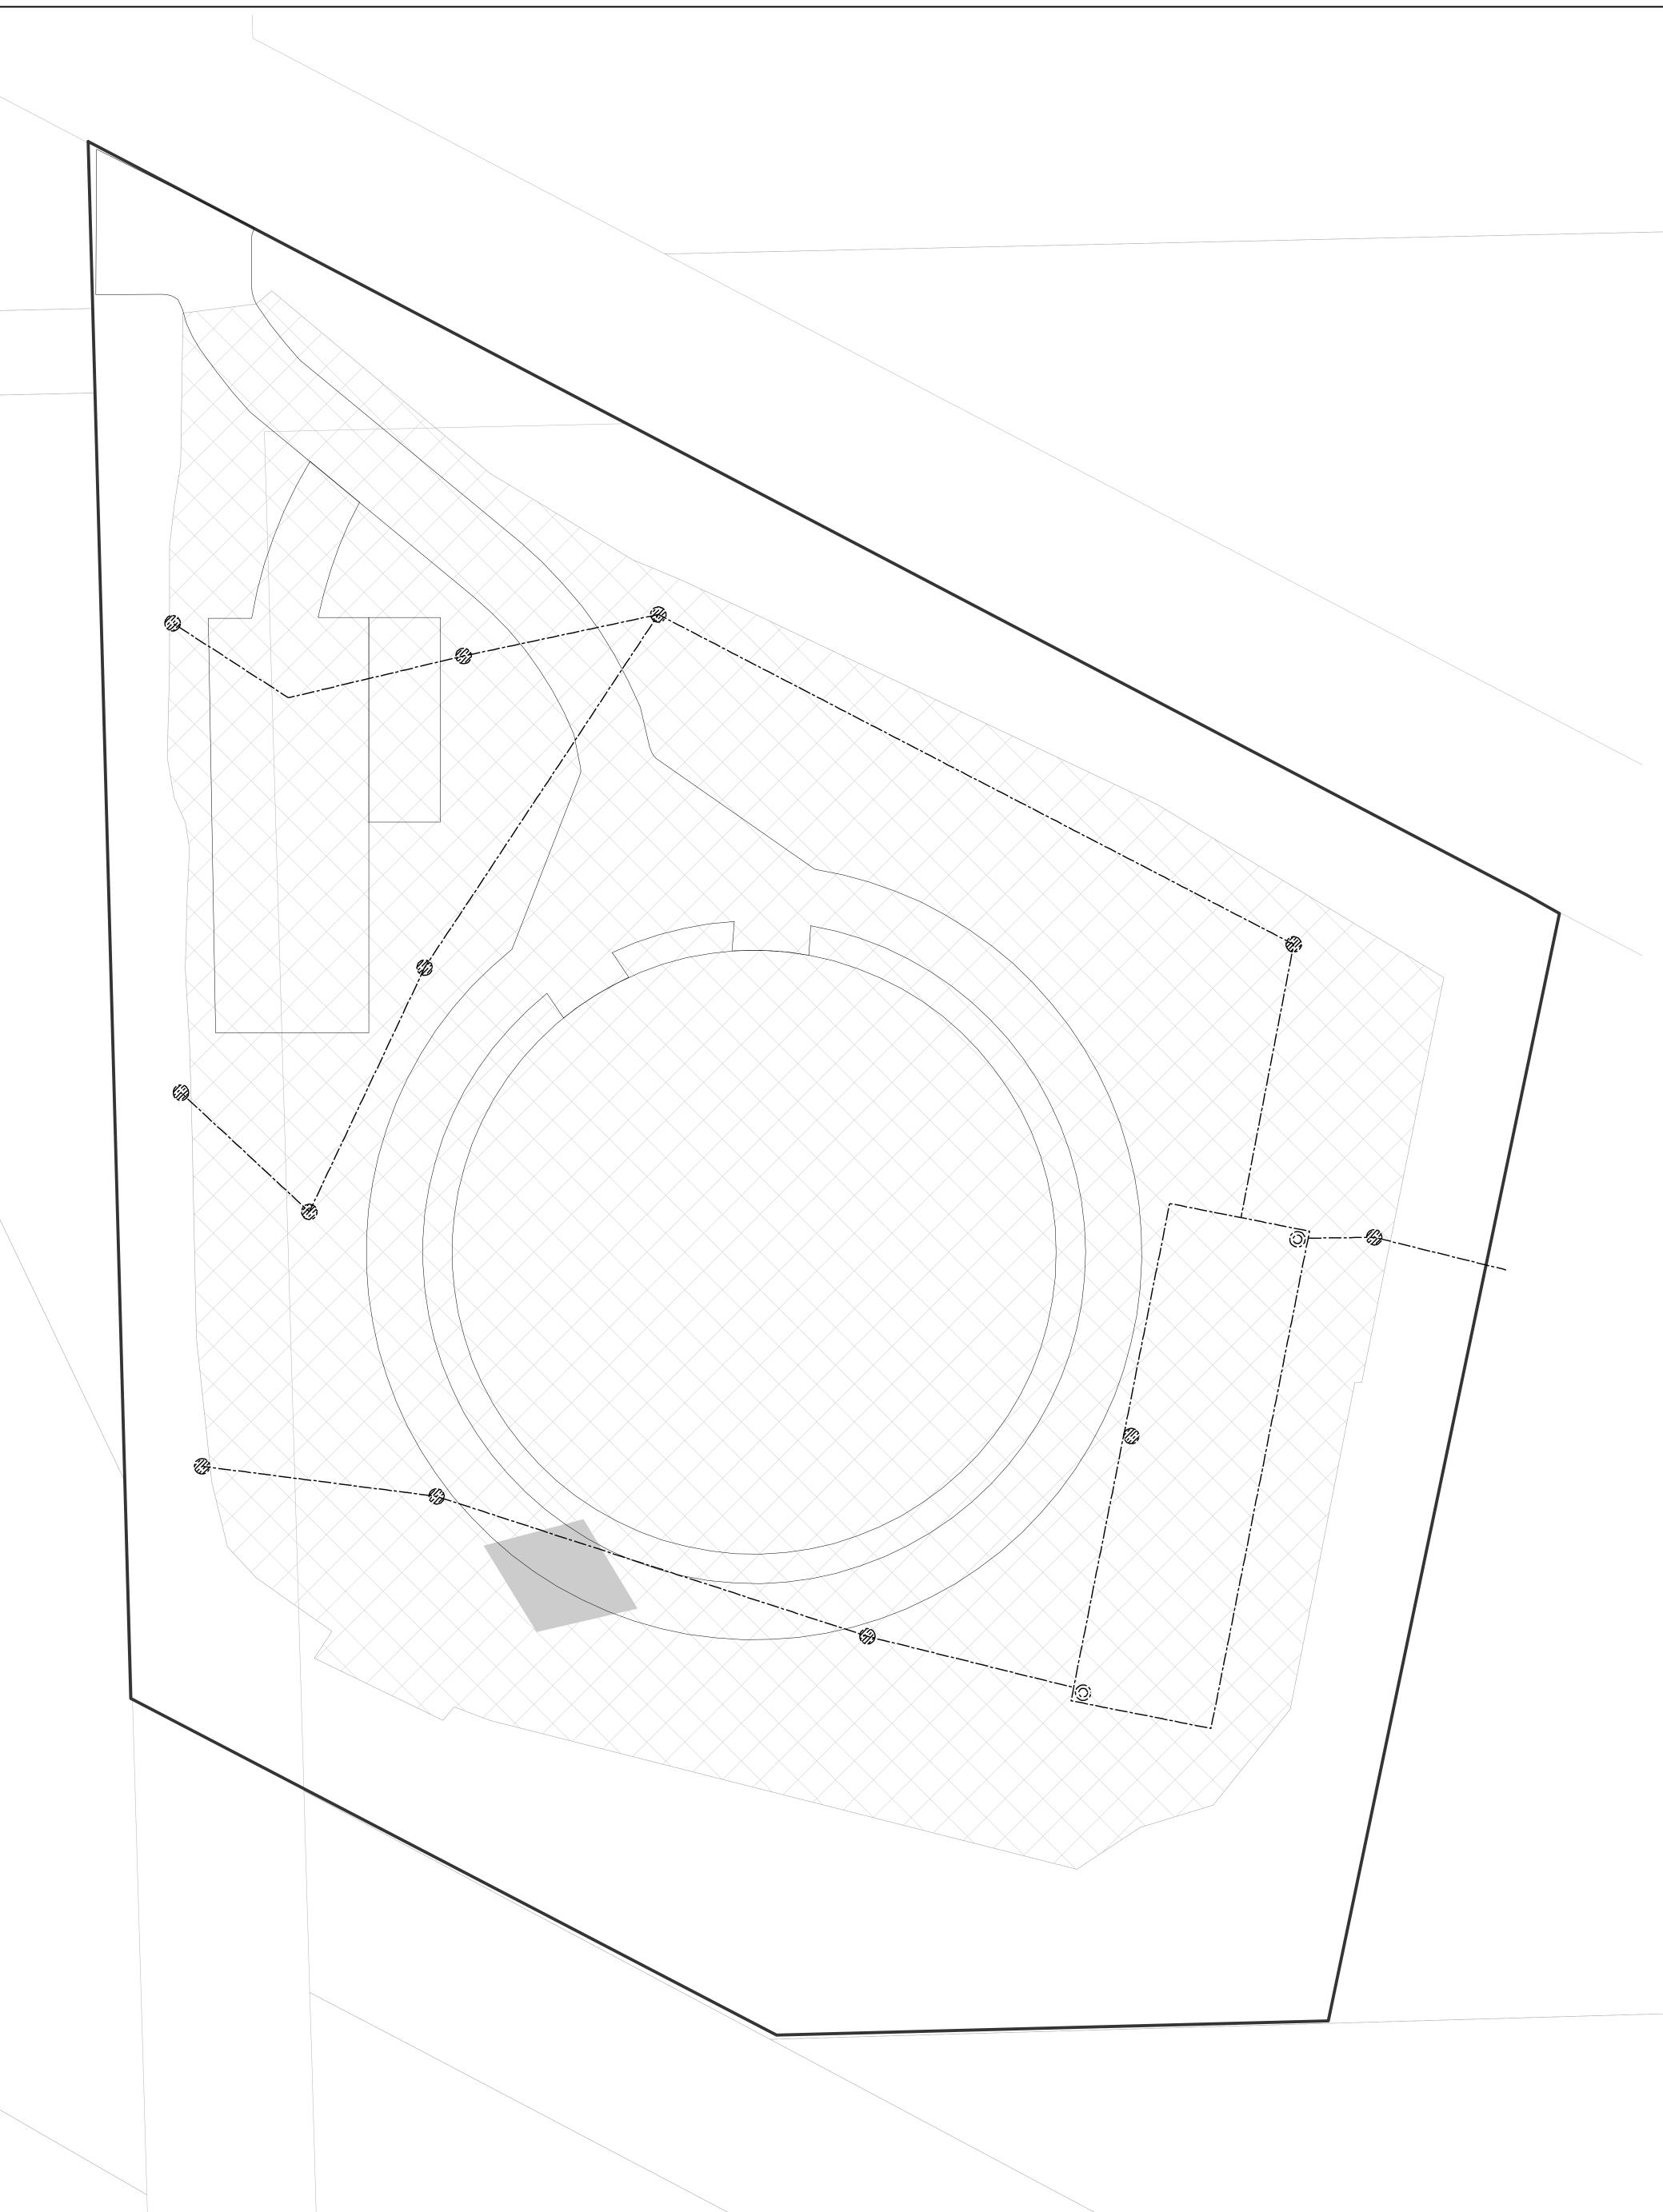

### Legend

- ---STORM SEWER
- AREA OF HAZARDOUS LEAD IN SOIL
- NON-HAZARDOUS, NON-SPECIAL WASTE SOIL (SUBTITLE D LANDFILL)
- □ PLANNED SITE FEATURES
- ■SUBJECT PROPERTY BOUNDARY
- PARCEL BOUNDARY

### NOTES:

- 1. THIS DRAWING IS ONLY FOR ENVIRONMENTAL SITE WORK (ILLUSTRATION PURPOSES ONLY.) CONTRACTOR SHALL REFER TO ARCHITECT/ENGINEER DRAWINGS FOR CONSTRUCTION DETAILS AND DIMENSIONS. REFER TO SITE SURVEY FOR EXISTING SURFACE ELEVATIONS.
- 2. CONTRACTOR SHALL VERIFY ALL DIMENSIONS AND FIELD CONDITIONS. ALL DIMENSIONS AND DETAILS ARE TAKEN FROM RECORD DRAWINGS AND ARE NOT GUARANTEED TO BE ACCURATE, CONTRACTOR SHALL FIELD VERIFY ACTUAL FIELD DIMENSIONS.
- 3. THE CONTRACTOR SHALL PREPARE A SITE SPECIFIC HEALTH AND SAFETY PLAN AND PERFORM ALL WORK IN ACCORDANCE WITH ALL APPLICABLE OSHA REGULATIONS.
- 4. SOIL EXCAVATION SHALL BE KEPT TO THE EXTENT REQUIRED TO PERFORM THE PROPOSED CONSTRUCTION WORK AS SPECIFIED IN THE CONTRACT DOCUMENTS.
- 5. ALL EXCAVATION, TRANSPORTATION AND DISPOSAL OF SOIL/FILL SHALL BE PERFORMED IN
- ACCORDANCE WITH SPECIFICATION SECTION 31 23 18.13.

  6. CONTRACTOR SHALL PROVIDE THE NAME AND ADDRESS OF SELECTED HAULERS, RECYCLING FACILITY,
- AND ACTIVE PERMITTED SUBTITLE D LANDFILL PER SPECIFICATION SECTION 31 23 18.13 PRIOR TO THE START OF CONTRACTOR WORK.
- 7. ALL FIELD EQUIPMENT SHALL BE DECONTAMINATED PRIOR TO BEING TAKEN OFFSITE OR USED IN UNCONTAMINATED SOIL AREAS.
- 8. CLEAN CONCRETE AND/OR ASPHALT REMOVED DURING EXCAVATION/DEMOLITION WORK CAN BE TRANSPORTED TO THE APPROVED RECYCLING FACILITY. CONCRETE RUBBLE COMMINGLED, MIXED OR CROSS CONTAMINATED WITH GENERAL CONSTRUCTION & DEMOLITION DEBRIS SHALL BE HANDLED IN ACCORDANCE WITH SPECIFICATION SECTION 31 23 18.13.
- 9. ALL IMPORTED FILL MATERIALS MUST MEET THE REQUIREMENTS OF SPECIFICATION SECTION 31 23 23 25. ALL IMPORTED FILL MATERIALS USED FOR THE PROJECT SHALL NOT EXCEED APPENDIX B, SECTION 742, AND TABLE A; TIERED APPROACH TO CORRECTIVE ACTION OBJECTIVES (TACO): 35 ILLINOIS ADMINISTRATIVE CODE (ILL. ADM. CODE) 742 VALUES FOR 35 ILL. ADM. CODE 740 APPENDIX A TARGET COMPOUND LIST (TCL) PARAMETERS.

  10. EXISTING ASPHALT GRINDINGS ARE ALLOWED TO REMAIN IN PLACE ON THE SURFACE OF THE SITE IF THEY ARE UNDISTURBED. ASPHALT GRINDINGS THAT ARE EXCAVATED SHOULD BE DISPOSED OFFSITE AT AN ASPHALT RECYCLING FACILITY OR SUBTITLE D LANDFILL IN ACCORDANCE WITH SPECIFICATION SECTION 31 23 18.13.

  11. SHOULD ANY SOILS OR FILL BE ENCOUNTERED THAT EXHIBIT UNUSUAL OR PETROLEUM/SOLVENT ODORS OR STAINING, CONTRACTOR SHALL STOP WORK IN THAT AREA AND NOTIFY THE COMMISSION REPRESENTATIVE IMMEDIATELY. CONTRACTOR SHALL IMMEDIATELY NOTIFY THE COMMISSION REPRESENTATIVE IF ANY MATERIALS (SOIL OR LIQUID) REQUIRING SPECIAL HANDLING (I.E. STAINED SOIL, SOIL WITH ODORS, OR LIQUIDS) ENCOUNTERED DURING EXCAVATION
- 12. NO SOIL SHALL BE EXPORTED FROM OR IMPORTED TO THE SITE WITHOUT THE PRESENCE OF THE ENVIRONMENTAL CONSULTANT (EC). NOTIFY THE COMMISSION REPRESENTATIVE AND EC AT LEAST 48 HOURS IN ADVANCE FOR FIELD OVERSIGHT AND DOCUMENTATION OF CCDD AND GENERAL CONSTRUCTION AND DEMOLITION DEBRIS REMOVAL PER SPECIFICATION SECTION 02 65 00 AND SPECIFCATION SECTION 31 23 18.13. 13. SHOULD AN UNDERGROUND STORAGE TANK (UST) BE ENCOUNTERED IN THE WORK AREA, CONTRACTOR SHALL STOP WORK AND NOTIFY THE COMMISSION REPRESENTATIVE AND EC IMMEDIATELY IN
- ACCORDANCE WITH SPECIFICATION SECTION 02 65 00.

  14. ALL IMPORTED BACKFILL USED FOR THE PROJECT SHALL NOT EXCEED APPENDIX B, SECTION 742, AND TABLE
  A; TIERED APPROACH TO CORRECTIVE ACTION OBJECTIVES (TACO): 35 ILLINOIS ADMINISTRATIVE CODE (ILL. ADM. CODE)
  742 VALUES FOR 35 ILL. ADM. CODE 740 APPENDIX A TARGET COMPOUND LIST (TCL) PARAMETERS.

  15. PRIOR TO COMMENCING WORK, THE CONTRACTOR SHALL PROVIDE A STORM WATER
  MANAGEMENT PLAN THAT SHALL COMPLY WITH ALL LOCAL, STATE AND FEDERAL RULES AND REGULATIONS, AS WELL
  AS OTHER RELEVANT CONTRACT DOCUMENTS. CONTRACTOR SHALL BE RESPONSIBLE FOR PREPARING
  STORM WATER MANAGEMENT PLAN AND OBTAINING PUMPING PERMIT FROM THE CITY OF CHICAGO DEPARTMENT
- OF GREATER CHICAGO (MWRDGC) PRIOR TO DISCHARGE OF WATER INTO CITY SEWER SYSTEM IN ACCORDANCE WITH CONTRACT SPECIFICATIONS.

  16. REFER TO THE PHASE I ENVIRONMENTAL SITE ASSESSMENT OF THE GRAND AVENUE SALT STORAGE YARD, (AECOM, JUNE 2020) AND PHASE II ENVIRONMENTAL SITE ASSESSMENT (AECOM, DECEMBER 2020) FOR ADDITIONAL INFORMATION AS REFERENCED IN SPECIFICATION SECTION 02 24 00.

OF BUILDINGS AND DISCHARGE AUTHORIZATION/APPROVAL FROM METROPOLITAN WATER RECLAMATION DISTRICT

- 17. BUILDING DEBRIS MAY BE ENCOUNTERED. SHOULD ANY SUSPECT ASBESTOS MATERIAL BE ENCOUNTERED, CONTRACTOR SHALL STOP WORK IN THE AREA OF SUSPECT MATERIAL AND IMMEDIATELY NOTIFY THE COMMISSION REPRESENTATIVE AND THE EC.
- 18. LEAD-BASED PAINT MAY BE PRESENT AT THE PROPERTY. IT IS RESPONSIBILITY OF THE CONTRACTOR TO TAKE APPROPRIATE SAFETY MEASURES IN ACCORDANCE WITH APPLICABLE LOCAL, STATE AND FEDERAL RULES AND REGULATIONS INCLUDING OSHA (1962.62) COMPLIANCE WASTE CHARACTERIZATION, AND WASTE DISPOSAL.

  19. THE CONTRACTOR SHALL MANAGE THE IDENTIFIED HAZARDOUS LEAD SOIL IN ACCORDANCE WITH SPECIFICATION SECTION 31 23 18.15 AND/OR SPECIFICATION SECTION 31 90 00. THE CONTRACTOR SHALL IDENTIFY THE HAZARDOUS LEAD MANAGEMENT STRATEGY IN THE SOIL MANAGEMENT PLAN PER THE REFERENCED SPECIFICATIONS. THE EC SHALL PERFORM CONFIRMATION SAMPLING AS REFERENCED IN SPECIFICATION SECTION 31 90 00 PRIOR TO SOIL EXCAVATION, TRANSPORTATION AND DISPOSAL AT A SUBTITLE D LANDFILL. IF THE CONTRACTOR INCLUDES EXCAVATION, TRANSPORTATION AND DISPOSAL OF HAZARDOUS LEAD SOILS AT A SUBTITLE C LANDFILL AS A CHARACTERISTIC HAZARDOUS WASTE, THE CONTRACTOR SHALL NOTIFY THE COMMISSION AND PREPARE ALL NECESSARY DOCUMENTATION FOR OFF-SITE MANAGEMENT OF SAID MATERIAL INCLUSIVE OF ANY AND ALL RCRA GENERATOR DOCUMENTATION FOR APPROVAL BY THE COMMISSION.
- SOIL REQUIRE EITHER SUBTITLE C DISPOSAL OR STABILIZATION AND SUBTITLE D DISPOSAL, AS DESCRIBED IN THE ASSOCIATED SPECIFICATION SECTIONS.

  21. IF CONTRACTOR ELECTS TO PERFORM LEAD STABILIZATION TO ADDRESS HAZARDOUS LEAD IN SOIL IN ACCORDANCE

20. CONTRACTOR SHOULD ASSUME THAT 356 CUBIC YARDS (APPROX. 570 TONS) OF SOIL IN THE AREA OF HAZARDOUS LEAD IN

21. IF CONTRACTOR ELECTS TO PERFORM LEAD STABILIZATION TO ADDRESS HAZARDOUS LEAD IN SOIL IN ACCORDANCE WITH SPECIFICATION SECTION 31 90 00, THE CONTRACTOR SHALL ASSUME NO LESS THAN 23 TONS OF STABILIZATION REAGENT (IF USING TERRABOND®) WILL BE REQUIRED.





Avenue)

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S12

'acility (Grand Aver 255 W GRAND AVE CHICAGO, IL 60612

Engineer of Record:
HBK ENGINEERING, LLC.



David Mason and Associates, Inc. Chicago, IL

Civil Engineer of Record

FORMA Architecture, Ltd.
Chicago, IL

**Architect of Record** 

Delta Engineering Group, LLC Chicago, IL Electrical Engineer of Record

DomTec International Idaho Falls, ID Structural Engineer of Record


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	IFB Addendum - 4	1/27/2

PBC Contact No: C1598
Project No.: 04021

SOIL MANAGEMENT PLAN

Sheet

SM-1

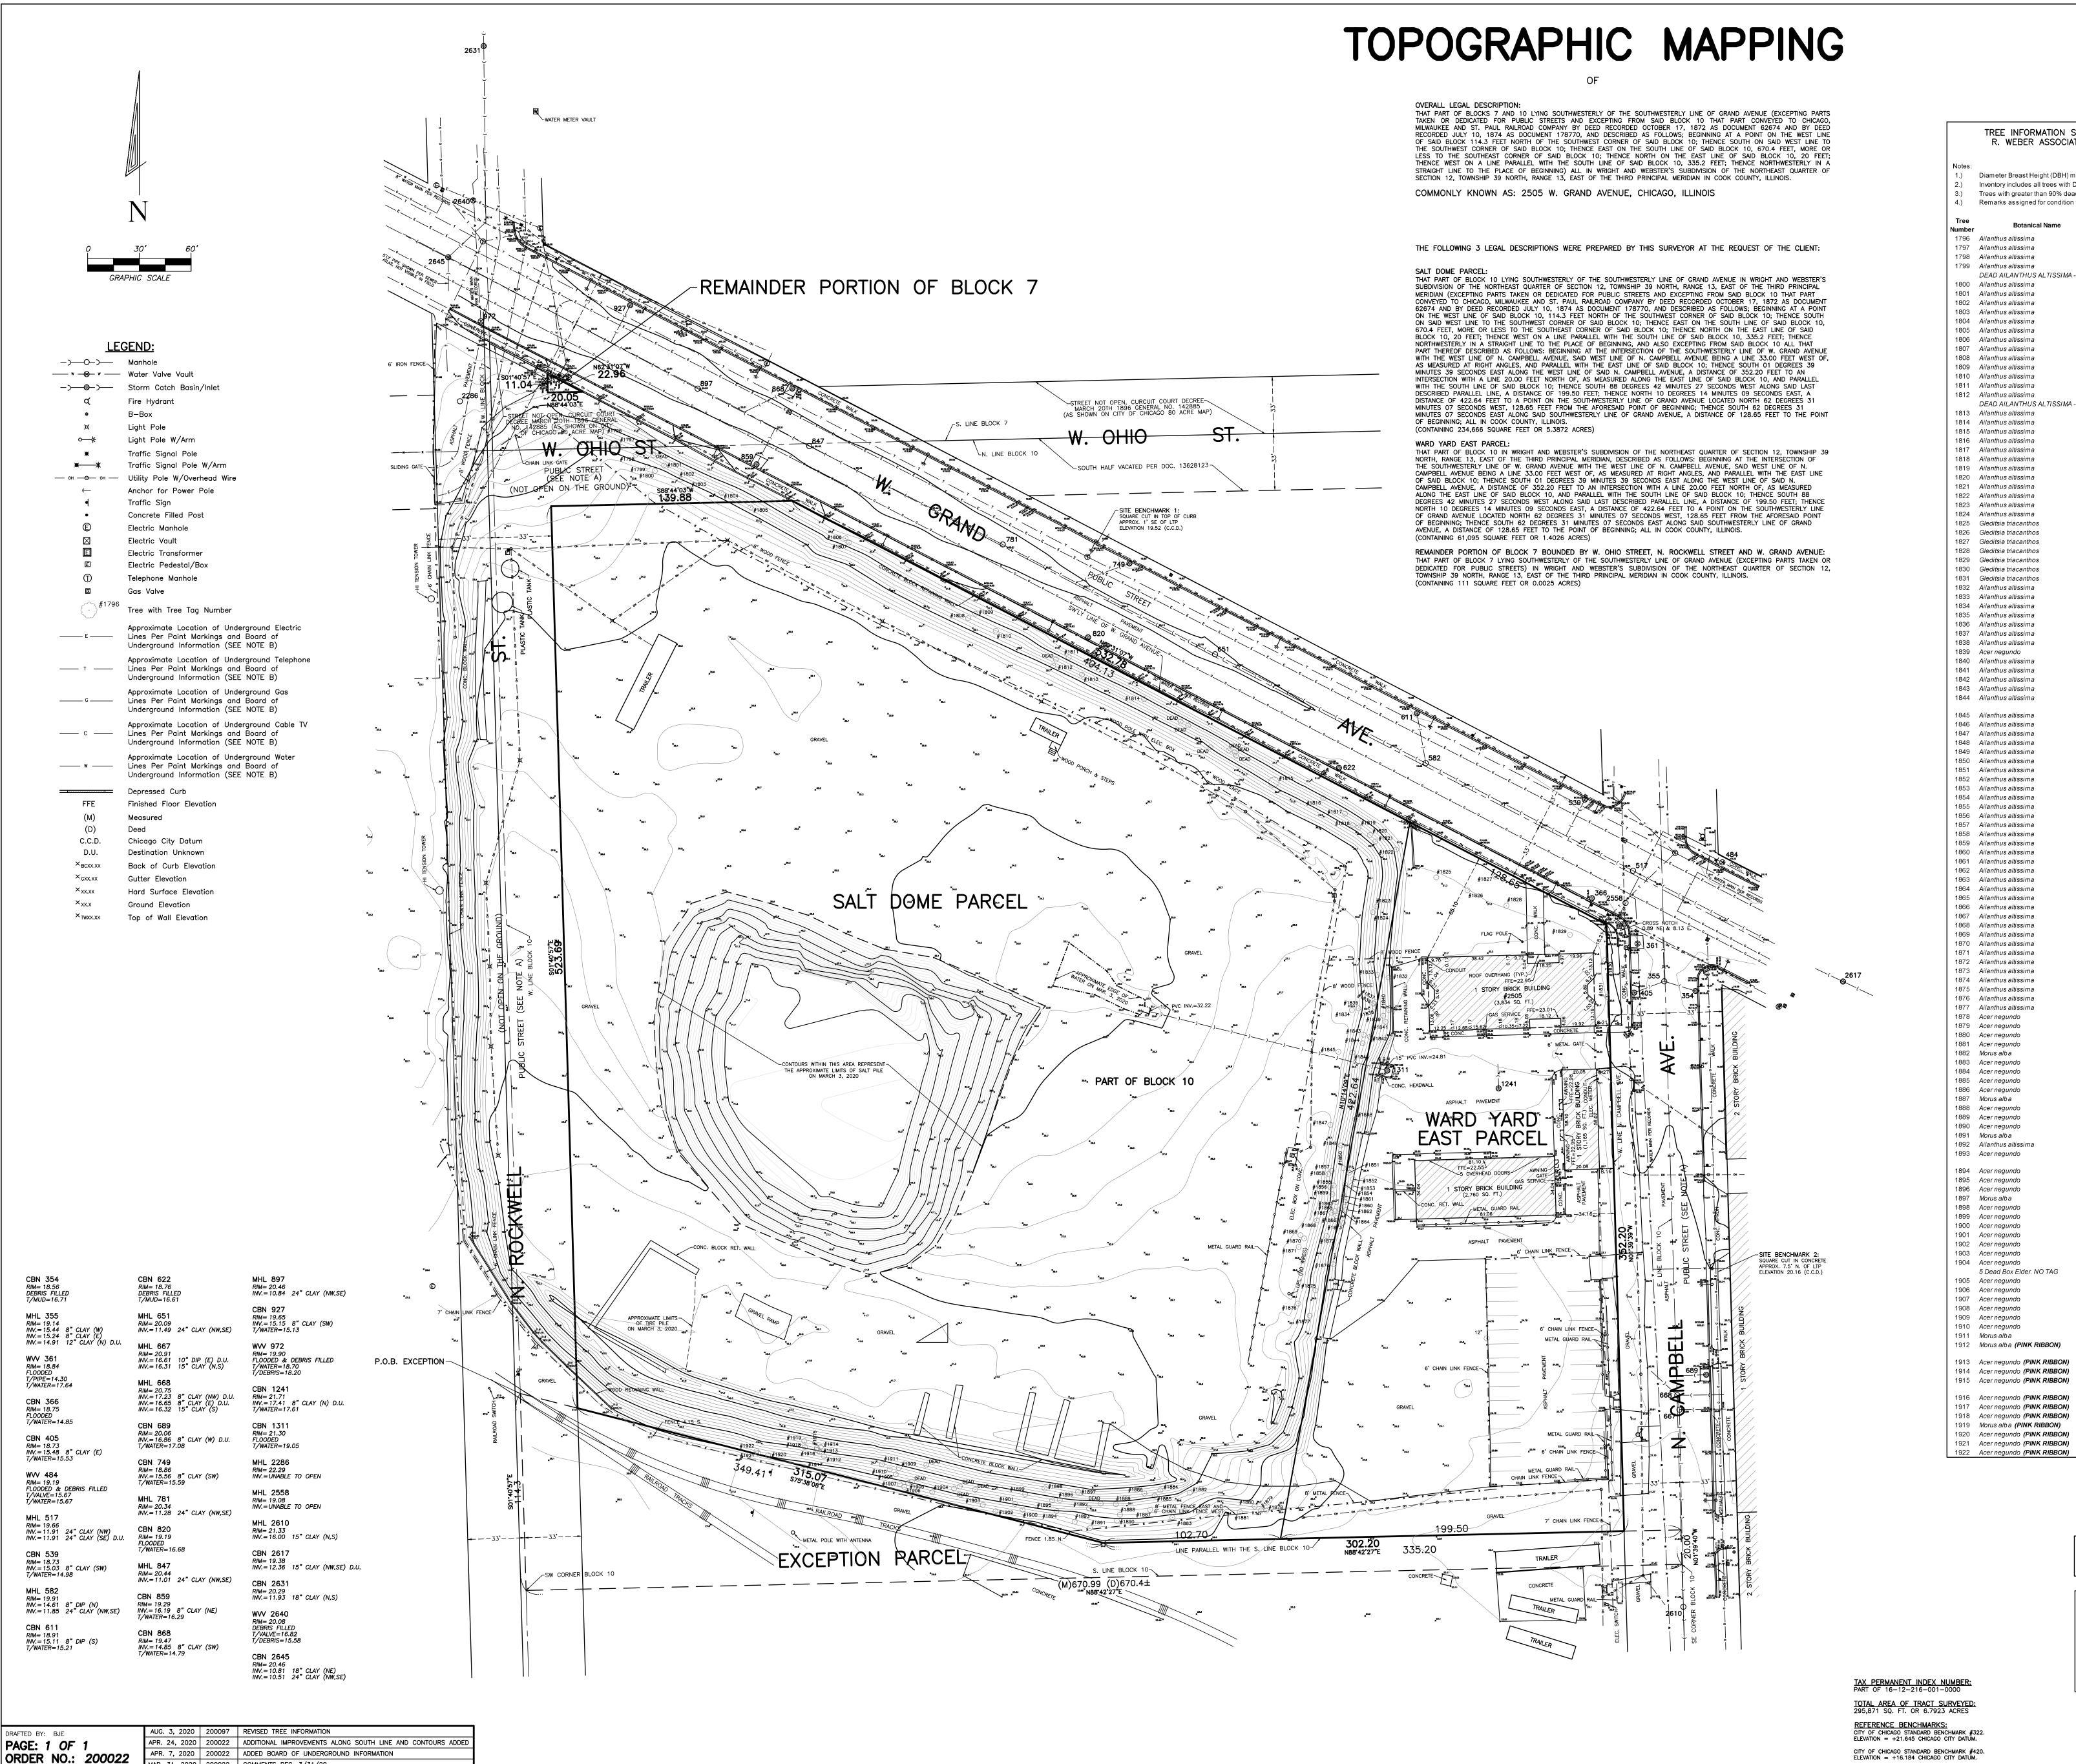

IAR. 31, 2020 | 200022 | COMMENTS REC. 3/31/20

MAR. 16, 2020 | 200022 | TOPOGRAPHIC MAPPING

EVISION DATE ORDER NO. REVISION

FILE: 12-39-13

PROJECT NO.: 2614

R. WEBER ASSOCIATES, INC. UNDER CONTRACT WITH THOMAS A. MOLLOY, LTD. Diameter Breast Height (DBH) measured at 4.5 ft from ground Inventory includes all trees with DBH over 4" Trees with greater than 90% deadwood in the crown were not tagged but noted Remarks assigned for condition vary between excellent, good, fair, and poor. 1796 Ailanthus altissima 1797 Ailanthus altissima Tree of Heaven Fair trunk scar, dead limb 1798 Ailanthus altissima Tree of Heaven 1799 Ailanthus altissima Tree of Heaven Poor major trunk damage DEAD AILANTHUS ALTISSIMA - NO TAG 1800 Ailanthus altissima Tree of Heaven Fair crowded 1801 Ailanthus altissima Tree of Heaven Fair trunk damage 1802 Ailanthus altissima Tree of Heaven Fair trunk damage 1803 Ailanthus altissima Tree of Heaven Fair leaning 1804 Ailanthus altissima 1805 Ailanthus altissima Tree of Heaven 1806 Ailanthus altissima Tree of Heaven 1807 Ailanthus altissima Tree of Heaven 1808 Ailanthus altissima Tree of Heaven Fair dead branches 1809 Ailanthus altissima Tree of Heaven 1810 Ailanthus altissima Tree of Heaven 1811 Ailanthus altissima Tree of Heaven Fair dead branches 1812 Ailanthus altissima Tree of Heaven Poor dead branches DEAD AILANTHUS ALTISSIMA - NO TAG 1813 Ailanthus altissima Tree of Heaven Fair dead branches 1814 Ailanthus altissima Tree of Heaven Fair dead branches 1815 Ailanthus altissima Tree of Heaven Poor severe lean dead branches 1816 Ailanthus altissima Fair dead branches 1817 Ailanthus altissima Tree of Heaven Fair dead branches 1818 Ailanthus altissima Tree of Heaven Fair dead branches 1819 Ailanthus altissima Tree of Heaven Fair dead branches 1820 Ailanthus altissima Tree of Heaven Fair dead branches 1821 Ailanthus altissima 1822 Ailanthus altissima Tree of Heaven Fair dead branches 1823 Ailanthus altissima Fair dead branches 1824 Ailanthus altissima Tree of Heaven Fair dead branches 1825 Gleditsia triacanthos Honey Locust Fair dead branches 1826 Gleditsia triacanthos Honey Locust Poor dead branches 1827 Gleditsia triacanthos Honey Locust Poor dead branches 1828 Gleditsia triacanthos Honey Locust Fair dead branches 1829 Gleditsia triacanthos Honey Locust Fair dead branches 1830 Gleditsia triacanthos 1831 Gleditsia triacanthos Honey Locust Fair dead branches 1832 Ailanthus altissima Tree of Heaven 1833 Ailanthus altissima Tree of Heaven Fair dead branches 1834 Ailanthus altissima Fair dead branches 1835 Ailanthus altissima Tree of Heaven Fair dead branches 1836 Ailanthus altissima Tree of Heaven Fair dead branches 1837 Ailanthus altissima Tree of Heaven Fair dead branches 1838 Ailanthus altissima Tree of Heaven 1839 Acer negundo dead branches, asphalt mound 1840 Ailanthus altissima Tree of Heaven Fair dead branches, asphalt mound 1841 Ailanthus altissima Tree of Heaven Fair dead branches, asphalt mound 1842 Ailanthus altissima 1843 Ailanthus altissima Tree of Heaven Fair dead branches, asphalt mound 1844 Ailanthus altissima Tree of Heaven Fair dead branches, asphalt mound dead limb, dead branches, 1845 Ailanthus altissima Tree of Heaven Poor asphalt mound 1846 Ailanthus altissima Fair dead branches, asphalt mound Fair dead branches, asphalt mound 1847 Ailanthus altissima Tree of Heaven 1849 Ailanthus altissima Fair dead branches, asphalt mound Fair dead branches, asphalt mound 1850 Ailanthus altissima Fair asphalt mound 1851 Ailanthus altissima Tree of Heaven Fair dead branches, asphalt mound 1852 Ailanthus altissima Tree of Heaven 1853 Ailanthus altissima Tree of Heaven Fair dead branches, asphalt mound 1854 Ailanthus altissima Tree of Heaven Fair dead branches, asphalt mound 1855 Ailanthus altissima Tree of Heaven Fair dead branches, asphalt mound 1856 Ailanthus altissima Tree of Heaven Fair dead branches, asphalt mound 1857 Ailanthus altissima Tree of Heaven Poor asphalt mound, strong lean 1858 Ailanthus altissima Fair asphalt mound Tree of Heaven 1859 Ailanthus altissima Fair asphalt mound 1860 Ailanthus altissima Fair asphalt mound Tree of Heaven 1861 Ailanthus altissima Fair asphalt mound 1862 Ailanthus altissima Tree of Heaven Fair asphalt mound 1863 Ailanthus altissima 1864 Ailanthus altissima Tree of Heaven Fair asphalt mound 1865 Ailanthus altissima Fair asphalt mound 1866 Ailanthus altissima Tree of Heaven Fair asphalt mound 1867 Ailanthus altissima Fair asphalt mound 1868 Ailanthus altissima Tree of Heaven Fair asphalt mound 1869 Ailanthus altissima Tree of Heaven Fair asphalt mound 1870 Ailanthus altissima Tree of Heaven Fair asphalt mound 1871 Ailanthus altissima Tree of Heaven Fair asphalt mound 1872 Ailanthus altissima Tree of Heaven Fair asphalt mound 1873 Ailanthus altissima Tree of Heaven Poor trunk rot: asphalt mound 1874 Ailanthus altissima Tree of Heaven Poor trunk rot; asphalt mound 1875 Ailanthus altissima Tree of Heaven Fair dead branches 1876 Ailanthus altissima Fair asphalt mound 1877 Ailanthus altissima Tree of Heaven Fair asphalt mound 1878 Acer negundo Poor fence proximity, dead branches 1879 Acer negundo Poor fence proximity, dead branches 1880 Acer negundo Poor fence proximity, dead branches 1881 Acer negundo Poor fence proximity, dead branches 1882 Morus alba White Mulberry Poor dead branches 1883 Acer negundo Poor leaning, asphalt mound 1884 Acer negundo Poor leaning, asphalt mound 1885 Acer negundo Poor leaning, asphalt mound Poor leaning, asphalt mound 1886 Acer negundo Box Elder 1887 Morus alba White Mulberry Poor leaning, asphalt mound 1888 Acer negundo Fair dead branches, asphalt mound 1889 Acer negundo Poor leaning, asphalt mound 1890 Acer negundo Box Elder 1891 Morus alba White Mulberry 1892 Ailanthus altissima Tree of Heaven Fair dead branches, asphalt mound 1893 Acer negundo Fair dead branches, asphalt mound leaning, broken limb, dead 1894 Acer negundo Poor branches 1895 Acer negundo Fair dead branches, asphalt mound 1896 Acer negundo Poor dead branches, dead limbs 1897 Morus alba White Mulberry Poor leaning, asphalt mound 1898 Acer negundo Poor leaning, asphalt mound Poor leaning, asphalt mound 1899 Acer negundo 1900 Acer negundo Poor leaning, asphalt mound Poor leaning, asphalt mound 1901 Acer negundo Box Elder 1902 Acer negundo Poor leaning, asphalt mound Poor dead branches, asphalt mound 1903 Acer negundo 1904 Acer negundo Poor leaning, asphalt mound 5 Dead Box Elder. NO TAG 1905 Acer negundo Poor leaning, asphalt mound 1906 Acer negundo Box Elder Poor leaning, asphalt mound 1907 Acer negundo Poor leaning, asphalt mound 1908 Acer negundo Poor leaning, asphalt mound 1909 Acer negundo Poor leaning, asphalt mound Box Elder

TREE INFORMATION SHOWN HEREON WAS PROVIDED TO THIS SURVEYOR BY GARY

NOTE A: CHICAGO DEPARTMENT OF TRANSPORTATION REPORTS THAT N. ROCKEWLL STREET, N. CAMPBELL AVENUE AND W. OHIO STREET ARE DEDICATED PUBLIC STREETS. NO SUPPORTING DOCUMENTATION PROVIDED OR FOUND. NOTE B: UNDERGROUND UTILITY LINES SHOWN HEREON ARE APPROXIMATE LOCATIONS BASED ON SURVEYOR'S REVIEW AND

6, 4, 4

Box Elder

Box Elder

Box Elder

SEE DRAWING FOR SITE BENCHMARKS.

White Mulberry

INTERPRETATION OF UTILITY RECORDS PROVIDED BY CITY OF CHICAGO DEPARTMENT OF TRANSPORTATION OFFICE OF UNDERGROUND COORDINATION PER OUC FILE #IR-101922 COMBINED WITH PHYSICAL SITE FEATURES AND PAINT MARKINGS OBSERVED IN THE PROCESS OF CONDUCTING THE FIELDWORK. HOWEVER, LACKING EXCAVATION, THE EXACT LOCATION OF UNDERGROUND FEATURES CANNOT BE ACCURATELY, COMPLETELY, AND RELIABLY DEPICTED. WHERE ADDITIONAL OR MORE DETAILED INFORMATION IS REQUIRED, THE CLIENT IS ADVISED THAT EXCAVATION AND/OR A PRIVATE UTILITY LOCATE REQUEST MAY BE NECESSARY.

EDWARD J. MOLLOY & ASSOCIATES A DIVISION OF THOMAS A. MOLLOY, LTD. - PROFESSIONAL LAND SURVEYING

1236 MARK STREET, BENSENVILLE, ILLINOIS 60106 (630) 595-2600 FAX:(630) 595-4700

E-MAIL: TMOLLOY@EJMOLLOY.COM

Poor leaning, asphalt mound

Poor leaning, asphalt mound

Poor leaning, asphalt mound

Poor severe lean, asphalt

Poor dead branches, lean

Poor dead branches

Poor leaning, ashpalt

Poor leaning, ashpalt Poor leaning, ashpalt

Poor leaning, ashpalt

Poor leaning, dead leader, asphalt trunk scar, dead branches.

trunk damage, dead limbs,

Poor broken leader, dead limbs, overgrown

O

**Engineer of Record:** 

HBK ENGINEERING, LLC.



921 WEST VAN BUREN STREET, SUITE 100

CHICAGO, ILLINOIS 60607

STATE OF ILLINOIS DEPARTMENT

OF PROFESSIONAL REGULATION. LICENSE NO. 184-002308

David Mason and Associates, Inc. Chicago, IL Civil Engineer of Record

**FORMA Architecture. Ltd.** Chicago, IL **Architect of Record** 

**Delta Engineering Group, LLC.** Chicago, IL **Electrical Engineer of Record** 

**DomTec International** Idaho Falls, ID Structural Engineer of Record

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k	Description	Date
	Schematic Design	8/31/2020
	Design Development	9/28/2020
	60% Construction Documents	10/28/2020
	90% Construction Documents	11/25/2020
	100% Construction Documents	12/18/2020
	Issue For Bid	1/8/2021
	Issue For Bid - Addendum #4	1/27/2021

PBC Project Name: Salt Dome Replacement Facility (Grand Avenue PBC Contract No: C1598 Project No.: 04021

TOPOGRAPHIC AND UTILITY SURVEY

**V0.1**